



HIGHWAY 7 ROAD RESTORATION DETAIL

SCALE 1:40

** TRENCH SHALL CONFORM TO MINISTRY OF LABOUR REGULATIONS IN REGARD TO WORK IN OPEN TRENCHES. CONTRACTOR SHALL USE A TRENCH BOX FOR EXCAVATION WORK ON HIGHWAY No. 7 IN ACCORDANCE WITH MTO ENCROACHMENT PERMIT.

NOTE:
- SAWCUT EXISTING ASPHALT EDGES PRIOR TO ROAD RESTORATION
- IF MACADAM PAVEMENT LAYER IS ENCOUNTERED IT SHALL BE
REMOVED AND DISPOSED OF IN ACCORDANCE WITH CURRENT
REGULATIONS.

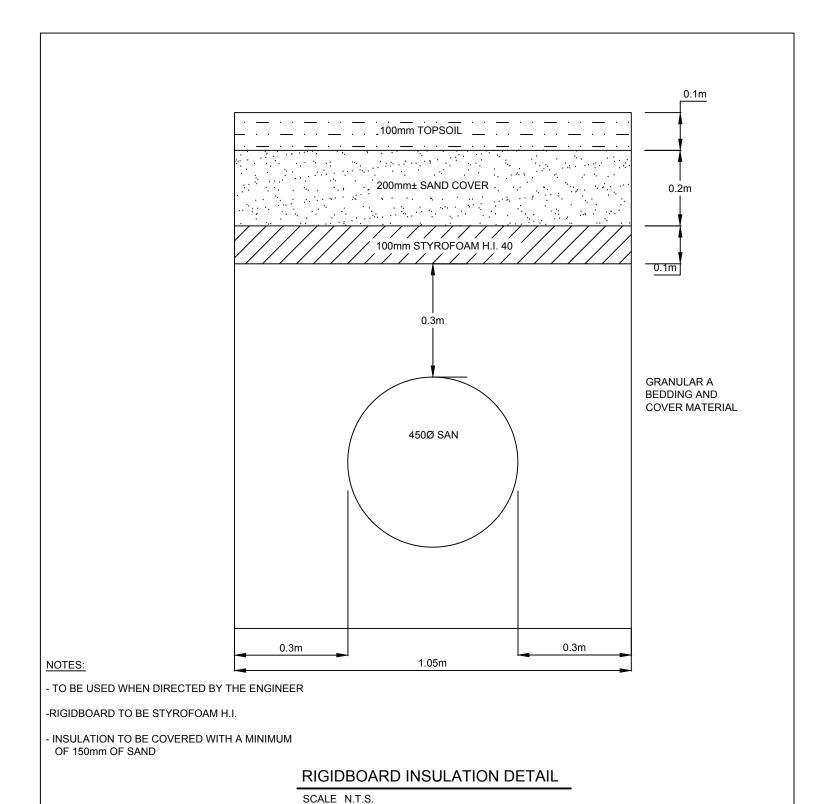


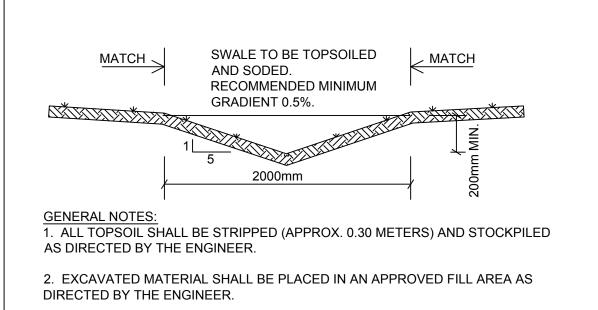



- 3. FINAL GRADING OF THE SITE SHALL BE AS INDICATED.
- 4. ALL SURVEY MONUMENTS SHALL BE LEFT INTACT. WHERE EXCAVATION IS REQUIRED ADJACENT TO MONUMENTS, CARE SHALL BE TAKEN TO ENSURE THEY ARE NOT DISTURBED.
- 5. SWALES TO BE LOCATED AS SHOWN ON THE GRADING AND DRAINAGE PLAN.

TYPICAL SWALE

SCALE N.T.S.

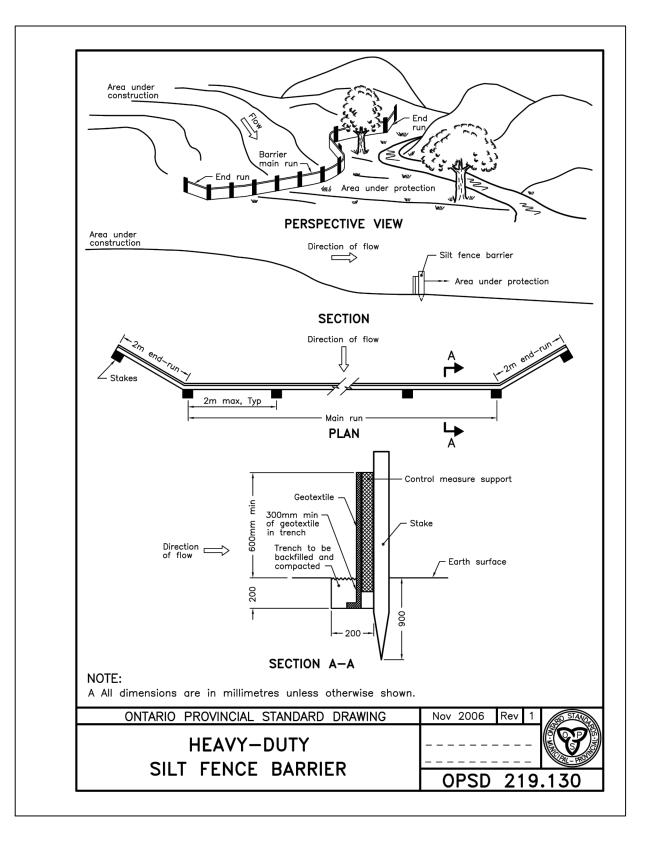

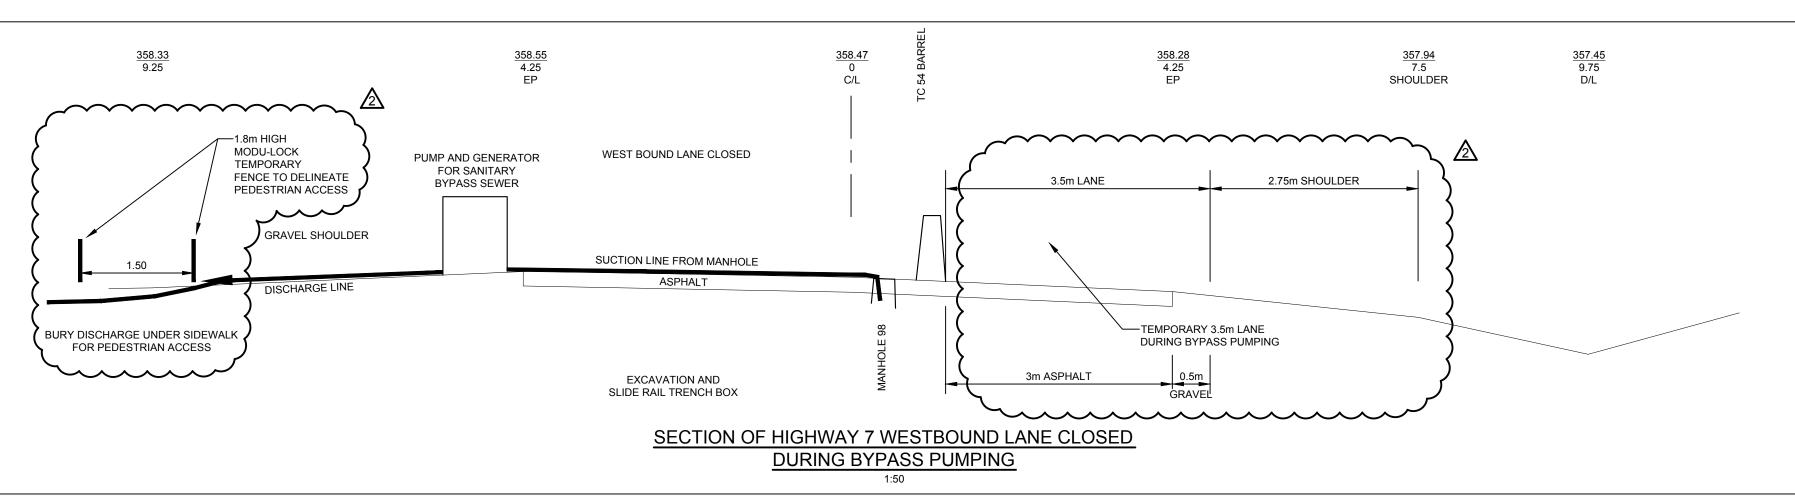

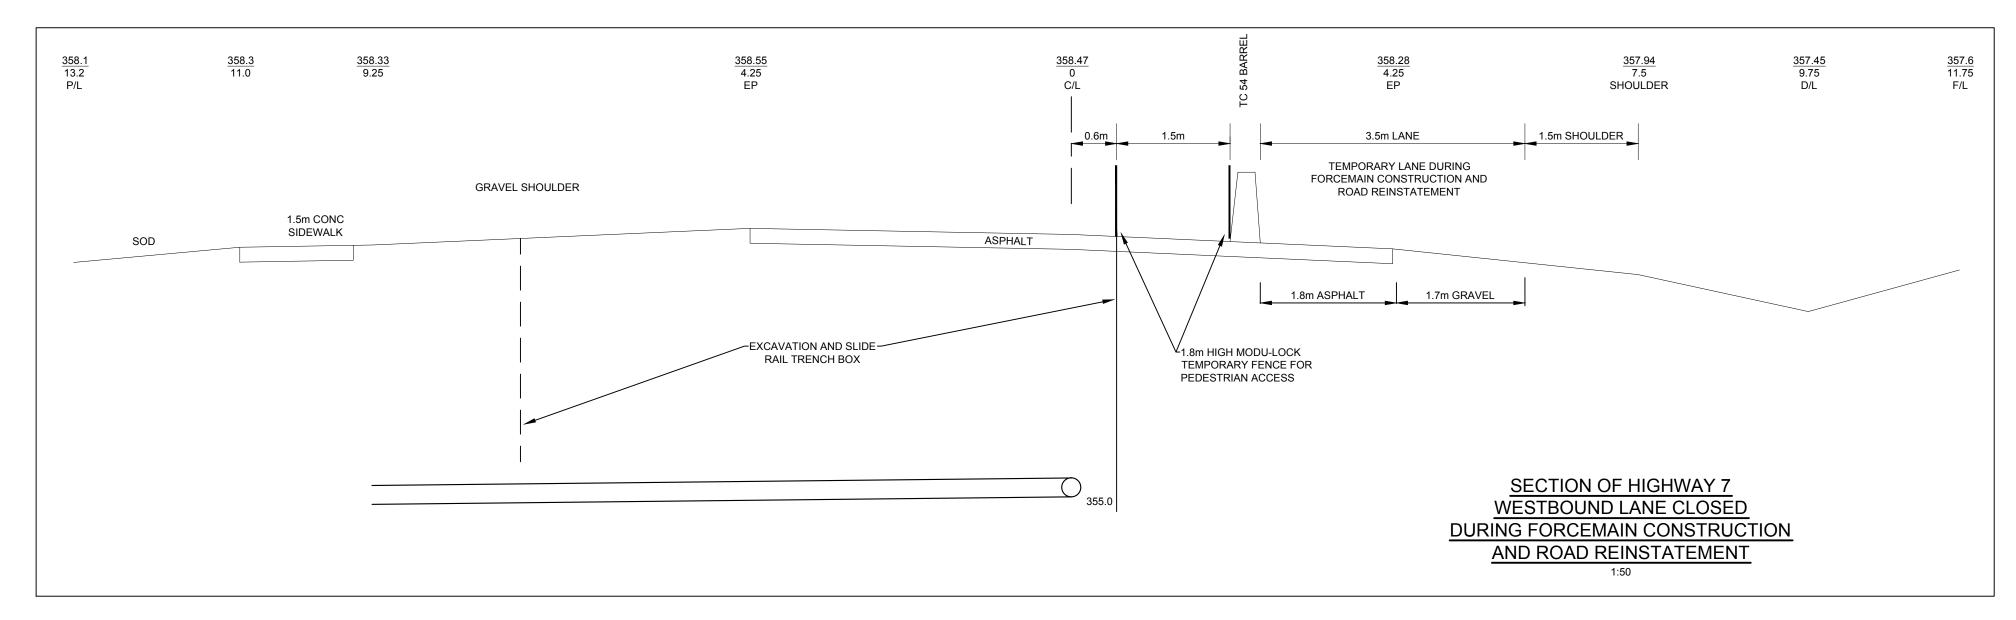

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- 2. The contractor shall verify all dimensions, levels, and datums on site and report any discrepancies
- This drawing is to be read and understood in conjunction with all other plans and documents applicable to this project.

No.	Issue / Revision	Date	Auth
1	DETAILS ADDED AS PER MTO COMMENTS	OCT. 2015	
2	ISSUED FOR 90% REVIEW	OCT. 2015	
2	ISSUED FOR TENDER	DEC. 2015	
4	REVISED AS PER MTO COMMENTS	JAN 2016	
5	REVISED AS PER ADDENDUM No. 2	JAN 2016	

BURNSIDE

R.J. Burnside & Associates Limited 292 Speedvale Ave. W., Unit 20 Guelph, Ontario, N1H 1C4 telephone (519) 823-4995 fax (519) 836-5477

ALMA ST. WASTEWATER
PRETREATMENT FACILITY UPGRADES
CIVIL DETAILS


TOWNSHIP OF GUELPH / ERAMOSA

8348 WELLINGTON ROAD 124, P.O. BOX 700
ROCKWOOD, ON
N0B 2K0

 Drawn
 Checked CADD
 Designed G.C.
 Checked J.L.L.
 Date JAN. 2015
 Drawing No.

 Project No. MSA143810.0062
 Contract No. MSA143810.0062
 Revision No. 5
 C003

 Scale NOT TO SCALE
 NOT TO SCALE
 Drawing No.
 C003

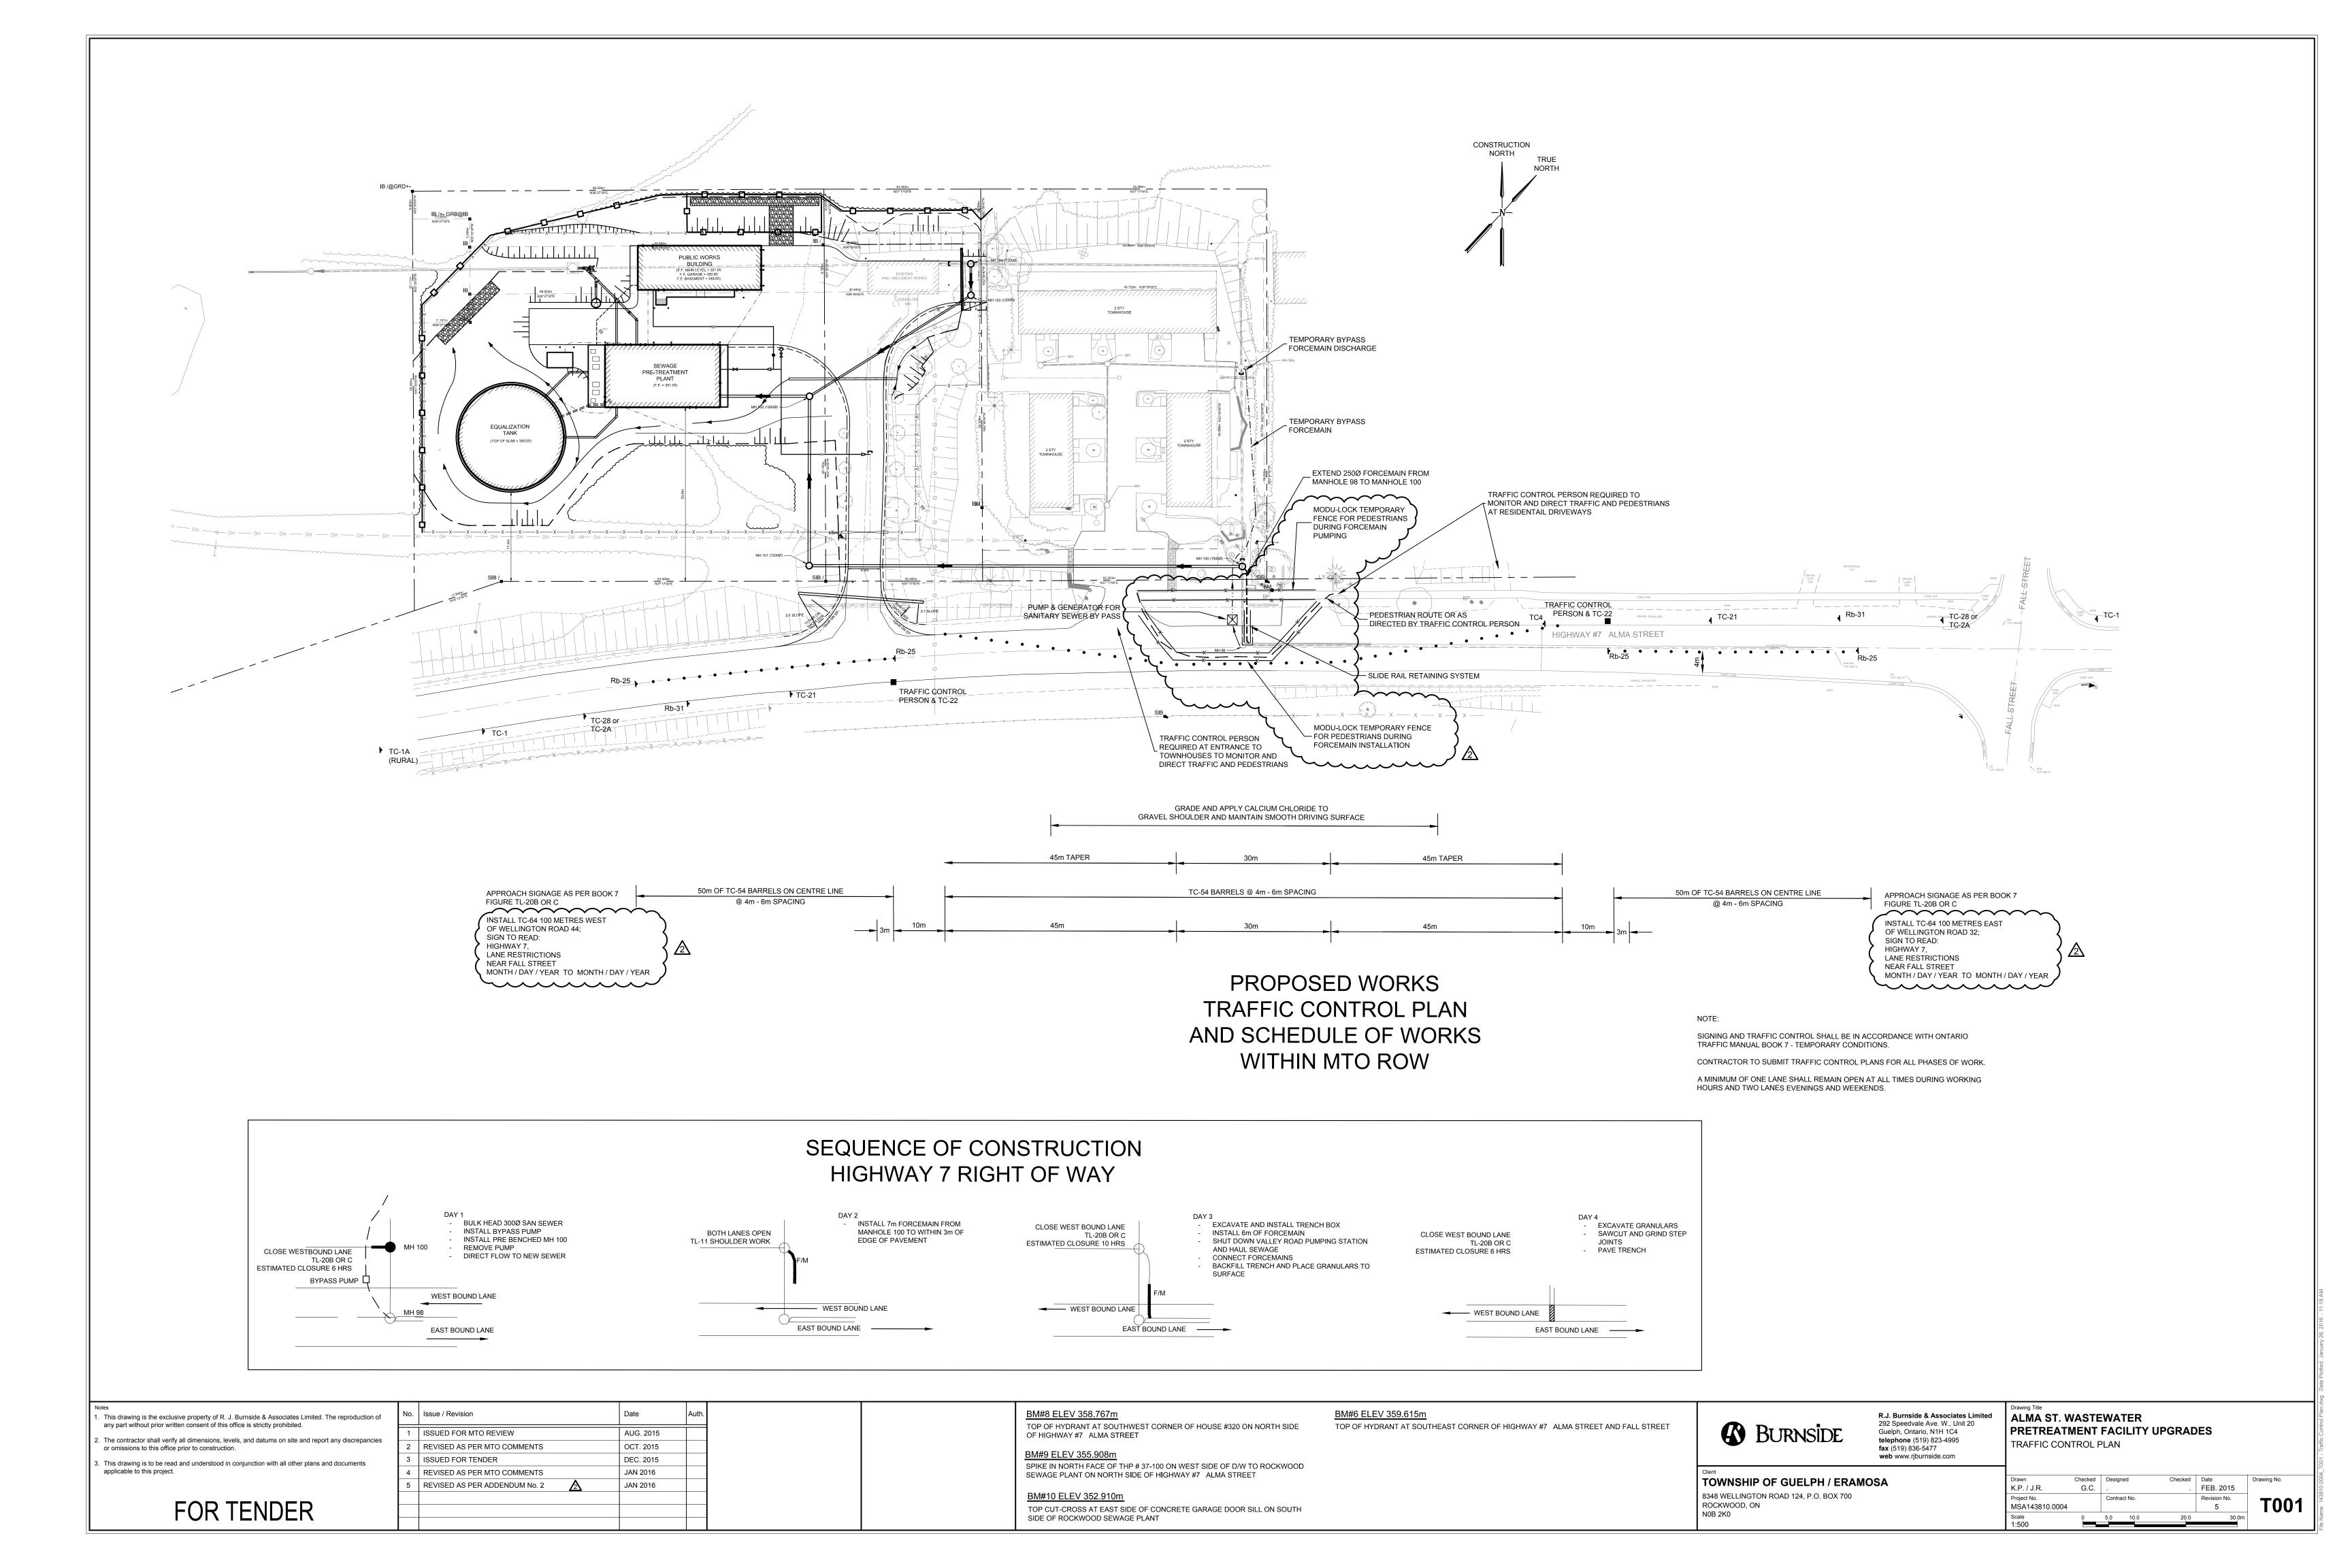

DOOR SCHEDULE DOOR NOMINAL SIZE DOOR FRAME MINIMUM FIRE FREE LABEL INSTALLATION TYPE MATERIAL FINISH ELEVATION THICK WIDTH HEIGHT TYPE MATERIAL FINISH ELEVATION REMARKS HARDWARE CODES 45 | 1100 | 2150 A,B,C,D,F,I,K,L,M,N,PHM INS-ST THM ST PT D102 45 900 2150 A,B,C,D,F,I,K,L,M,N,PНМ INS-ST THM ST RATED DOOR, FRAME & CLOSER OVERHEAD DOOR, POWER HM ST 1.5hr A,B,C,D,F,I,K,L,M,N,PHM INS-ST 45 900 2150 PT ST INS-ST - 3350 3050 OPENER (EXPLOSION PROOF) 45 | 1100 | 2150 A,B,C,D,F,I,K,L,M,N,PHM INS-ST THM ST D106 DOUBLE DOOR HM INS-ST 45 2200 2150 THM ST A,B,C,D,F,I,K,L,M,N,PA,B,C,D,F,I,K,L,M,N,PINS-ST 45 1100 2150 THM ST A,B,C,D,F,I,K,L,M,N,PINS-ST 45 | 1100 | 2150 | THM | ST | PT

1. INSULATE ALL EXTERIOR DOORS AND FRAMES, THERMAL

3. ALL DOORS LOCATED IN A FIRE SEPARATION ARE TO BE

BREAK FRAMES FOR NON-RATED EXTERIOR DOORS.

EQUIPPED WITH A POSITIVE LATCHING MECHANISM DESIGNED TO HOLD THE DOOR CLOSED AFTER EACH USE

IN ACCORDANCE TO ONTARIO BUILDING CODE ARTICLE

4. SEE SPECIFICATIONS FOR ADDITIONAL REQUIREMENTS

5. DOUBLE DOOR TO INCLUDE LOCKING THUMB LATCH ON EXTERIOR OF LEFT LEAF, SELF CLOSER ON LEFT LEAF WITH

HOLD OPEN, SWING LIMITING HOLD OPEN ON RIGHT LEAF,

DEAD BOLTS AT TOP AND BOTTOM ON RIGHT LEAF W/

2. ALL STEEL FRAMES TO BE WELDED.

3.1.8.13.

ASTRAGAL

ST = STEEL HM = HOLLOW METAL

THM = THERMALLY BROKEN HOLLOW METAL

INS-ST = INSULATED STEEL PT = PAINT

A. 1 1/2 PAIR TAMPERPROOF HEAVY DUTY HINGES B. DOOR CLOSER

C. SELF-LATCHING HARDWARE

D. LOCKABLE E. PASSAGE SET

F. PANIC HARDWARE

M. SWEEP

G. PUSH/PULL H. BARRIER FREE HARDWARE KICK PLATE INTERIOR

J. DOOR STOP

K. WEATHER STRIPPING L. THRESHOLD


N. KEY ACCESS FROM EXIT O. WASHROOM SET (PRIVATE)


P. WIND LIMITER (INTEGRAL WITH CLOSER) Q. UNIVERSAL BARRIER FREE SIGNAGE

R. POWER DOOR OPERATOR

FRAME ELEVATIONS DOOR ELEVATIONS

(TYP.)

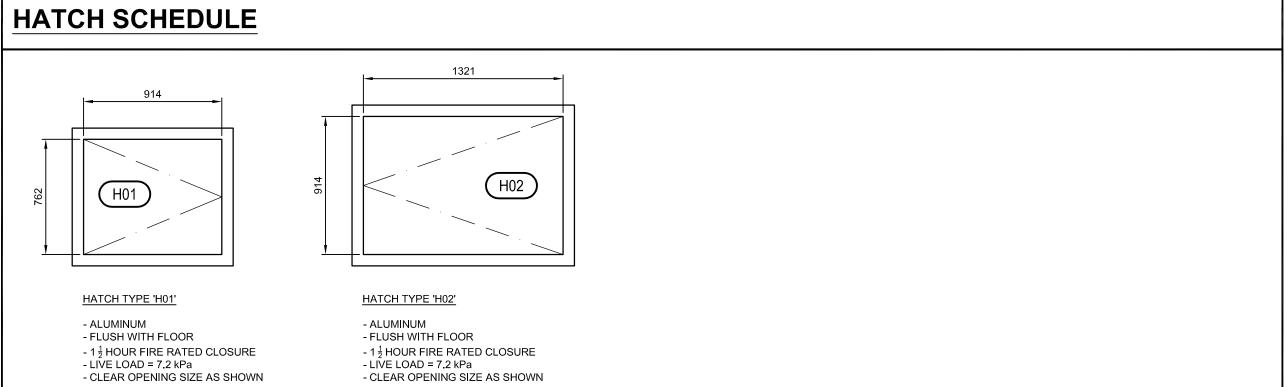

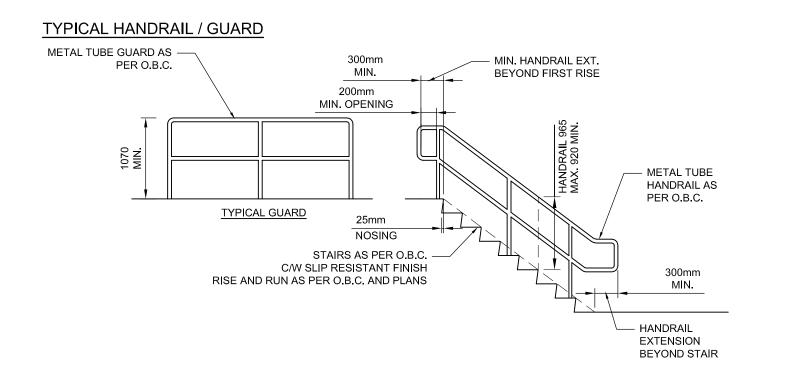

Issue / Revision

ISSUED FOR 90% REVIEW


REVISED AS PER ADDENDUM NO. 2

ISSUED FOR TENDER

CONSTRUCTION LEGEND

WALL TYPE W1 (O.B.C. SB-2 ADDITIVE 1hr F.R.R.) 38 PRE-FINISHED METAL SIDING 38x89 HORIZONTAL STRAPPING @ 600 0.C. AIR BARRIER 12.5mm EXTERIOR SHEATHING (PLYWOOD OR OSB)
38x140 SPF No. 2 OR BETTER WOOD STUDS @ 300mm O.C. ROCK WOOL BATT INSULATION 6 MIL. VAPOUR BARRIER 12.5 mm TYPE 'X' GYPSUM BOARD CORRUGATED PVC VERTICAL SIDING (CHEMICAL ROOM)


OBC MATRIX

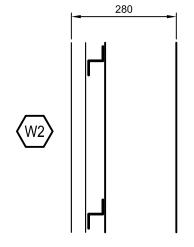


38 PRE-FINISHED METAL SIDING 50 HORIZONTAL GIRTS AT 600 0.C. 50 RIGID INSULATION, MIN. RSI 1.76 AIR BARRIER/VAPOUR BARRIER MEMBRANE SOUTH ELEVATION = 190 CONCRETE MASONRY

WALL TYPE W2

NORTH ELEVATION = 190 CONCRETE MASONRY UNIT, 60% SOLID UNITS TO MEET, O.B.C. SB-2, >2h F.R.R., EQUIV. THICK >113

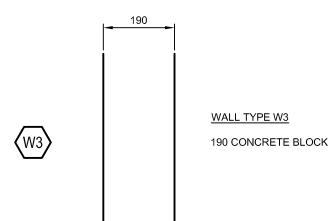


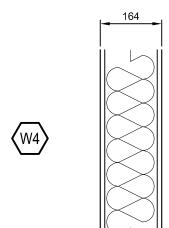

WALL TYPE W4

12mm TYPE 'X' GYPSUM BOARD 38x140 WOOD STUDS @ 400mm O.C. ROCK WOOL BATT INSULATION 12mm TYPE 'X' GYPSUM BOARD

CORRUGATED PVC VERTICAL SIDING (CHEMICAL ROOM)

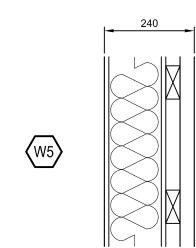

WALL TYPE W5 (STAIRS)

(ELECTRICAL ROOM/UTILITY ROOM) 12mm TYPE 'X' GYPSUM BOARD 38x140 WOOD STUDS @ 400mm O.C. ROCK WOOL BATT INSULATION 12mm TYPE 'X' GYPSUM BOARD POLY VAPOUR BARRIER (AROUND STAIRS) 38X89 HORIZONTAL STRAPPING @ 600 0.C. CORRUGATED PVC VERTICAL SIDING (STAIRS)

ltem					2012 Build					References are to	Reference	
_		_		Data i	Matrix Part	ა or 9				[A] for Division		
1	Project De	scription:			X N	lew		Part 11	□ Part	3	☑ Par	t 9
				Change of		Addition Alteration	11.	1 to 11.4	1.1.2. [A]		1.1.2. [9.10.1.	
2	Major Occ	upancy(s)	_ F2 - PRE	TREATMEN	FACILITY UF	PGRADES	•		3.1.2.1.(1)	9.10.2	
3	Building A	rea (m²)			New	F2 – 27	2.6 Tota	I F2 - 272.6	1.4.1.2.[A]	1.4.1.2.	[A]
4	Gross Are	a (m²)			New	F2 – 2 7	2.6 Tota	I F2 - 272.6	1.4.1.2.[A	.]	1.4.1.2.	[A]
5	Number of	•		Above Gro		Below	Grade -	1		3.2.1.1.	_	[A] & 9.10.4
6			Fire Fighter						3.2.2.10.	& J.Z.J.	9.10.20) .
7			n – GROUP	.t. DIVISION	2				3.2.2.71		9.10.2.	_
8	General Re					☐ Yes	⊠ No		·) [C] & Table		-
9	Sprinklered	System	Proposed				ed compa ed floor o of roof		3.2.2. 3.2.1.5. SEE INDE 3.2.2.17. 3.2.1.5. &	X & 3.2.2.15	9.10.8.4 9.10.8.3 9.10.1.3	
10	Standpipe	Required				☐ Yes	X No		3.2.9.		N/A	
11	Fire Alarm					☐ Yes	X No		3.2.4.		9.10.18	
12		•	y is Adequa	te			□ No		3.2.5.7.		N/A	
13	High Build		, .o macquu			□ Yes	■ No		3.2.6.		N/A	
14	Construction Actual Construction	on Restri		per	mbustible mitted mbustible	□ Non- requir	combustibl		3.2.2.		9.10.6.	
15	Mezzanine					_ ,,,,,,,			3.2.1.1.(3)_(<u>R</u>)	9.10.4.	1.
16	Occupant					▼ dooige	of buildi	na	3.1.17.)-(0)	9.9.1.3.	
10	1st Floor Total	lodd base	d on	0ccup		☒ desigr RSONS Loa RSONS Loa	d – 3 p	erson ersons	3.1.17.		9.9.1.3.	
17	Barrier-Fr	ee Design		☐ Yes	s 🗵 No		nat inton	dad to be accomised	3.8.		9.5.2.	
						on a daily	or full tir	ded to be occupied ne basis	3.8.1.1.(1)(c)	3.8.1.1.	(1)(c)
18	Hazardous	Substan	es	☐ Yes	s 🗵 No				3.3.1.2.	£ 3.3.1.19.	9.10.1.3	3.(4)
19	Required F Resistance Rating (FF	RR) _	Horizontal A FRR (hours) Floors — Roof — Mezzanine — FRR of Supp Members Floors — Roof —	0.75 hour: 0 hour: 0 hour:	Descrip s n/a s n/a s n/a Listed Descrip s n/a	Design No. of the No.	or SB-3)		3.2.2.		9.10.8. 9.10.9.	
			Nezzanine –									
20a	Spatial Se		- Constructi			ılle			3.2.3.			
20 u	Wall	Area of EBF (m²)	L.D. (m)	L/H or H/L	Permitted Max. % of	Proposed % of	FRR (hours)	Listed Design or Description	J.Z.J.	Comb Const	Comb Cons Nonc. Cladding	t Non-c
					Openings	Openings						
	West	51.7		<3:1	100	5.4	1.0	OBC. SB-2 additive as p			Х	
	East	51.7		<3:1	100	12.2	1.0	OBC. SB-2 additive as p			х	
		ration — i	Area of expo	_	ng face spli -	t as per 3.2 ⊤	.3.2.(2), L	.D. line at 5.0m fro		s office 5.6m	n from tre ⊤	atment plan
	NE. 2-3	20.3	5.6	<3:1	46.5	22	1.0	OBC. SB-2 additive as p			х	
	N. 3-4	52.00	5.6	3:1-10:1	20.8	19.7	2.0	SB-2, equiv. thick. > 11 Man door rated 1.5hr	3, ZNF FRR			х
	NW. 4-5	16.5	5.6	<3:1	38.9	13.2	1.0	OBC. SB-2 additive as p	er wall sched.		х	
	South	88.8	33.8	3:1-10:1	100	8.7	1.0 / 2.0	OBC. SB-2			х	
	Plumbing	Fixture Re	quirements					uired, building not occu ilable in nearby building		3.7.4.1.(3)	9	.31.1.1.(2).(c .7.4.1.(3)
21			F. 31 -									
21	Travel Dist	tances to	EXITS				rea < 200m²)				9	

No.	Poom Nama	North	North Wall		East Wall		ı Wall	West Wall		Floor		Ceiling		Comments	DOOM FINIOUS FORMS
NO.	Room Name	Material	Finish	Material	Finish	Material	Finish	Material	Finish	Material	Finish	Material	Finish	Comments	ROOM FINISH LEGEND
101	ELECTRICAL ROOM	GWB	PT	GWB	PT	GWB	PT	GWB	PT	CONC	cs	GWB	PT		CMU CONCRETE MASONRY UNIT
102	UTILITY ROOM	GWB	PT	СМИ	PT	GWB	PT	GWB	PT	CONC	cs	GWB	PT		CONC CONCRETE
103	STAIR	GWB	PVC	СМИ	PT	GWB	PVC	GWB	PVC	CONC	cs	GWB	PVC		GWB GYPSUM WALL BOARD
104	PROCESS ROOM	СМИ	PT	СМИ	PT	СМИ	PT	СМИ	PT	CONC	cs	PC	PT		EC EPOXY COATING
105	CHEMICAL ROOM	GWB	PVC	GWB	PVC	GWB	PVC	СМИ	PT	CONC	cs	GWB	PVC		PC PRECAST CONCRETE SLAB
106	BLOWER / UTILITY ROOM	GWB	PT	GWB	PT	GWB	PT	СМИ	PT	CONC	cs	GWB	PT		PT PAINT (COLOUR TO BE SELECTED BY OWNER)
															CS CONCRETE SEALED WITH CHEMICAL SEALER/HARDNER
001	WET WELL No. 1	CONC	_	CONC	-	CONC	-	CONC	-	CONC	-	CONC	-		PVC CORRUGATED PVC VERTICAL SIDING (SELECT BY OWNER)
002	WET WELL No. 2	CONC	-	CONC	-	CONC	-	CONC	-	CONC	-	CONC	-		
003	METER / VALVE ROOM	CONC	PT	CONC	PT	CONC	PT	CONC	PT	CONC	CS	CONC	PT		


N0B 2K0

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3. This drawing is to be read and understood in conjunction with all other plans and documents applicable to this project.

FOR	TENI	DER



OCT. 2015

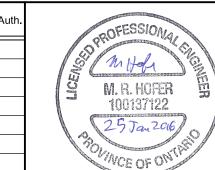DEC. 2015

JAN. 2016




R.J. Burnside & Associates Limited 292 Speedvale Ave. W., Unit 20 Guelph, Ontario, N1H 1C4 telephone (519) 823-4995 fax (519) 836-5477

web www.rjburnside.com

ALMA ST. WASTEWATER PRETREATMENT FACILITY UPGRADES ARCHITECTURAL MATRIX, WALL, DOOR & ROOM FINISH SCHEDULES

TOWNSHIP OF GUELPH / ERAMOSA 8348 WELLINGTON ROAD 124, P.O. BOX 700 ROCKWOOD, ON

Drawn	Checked	Designed	Checked	Date	Drawing No.
T.T.	M.H.	M.H.	M.H.	15/02/28	
Project No.		Contract No.		Revision No.	A 4 6
MSA143810.0062		MSA143810.0062		2	A10
Scale NOT TO SCALE					

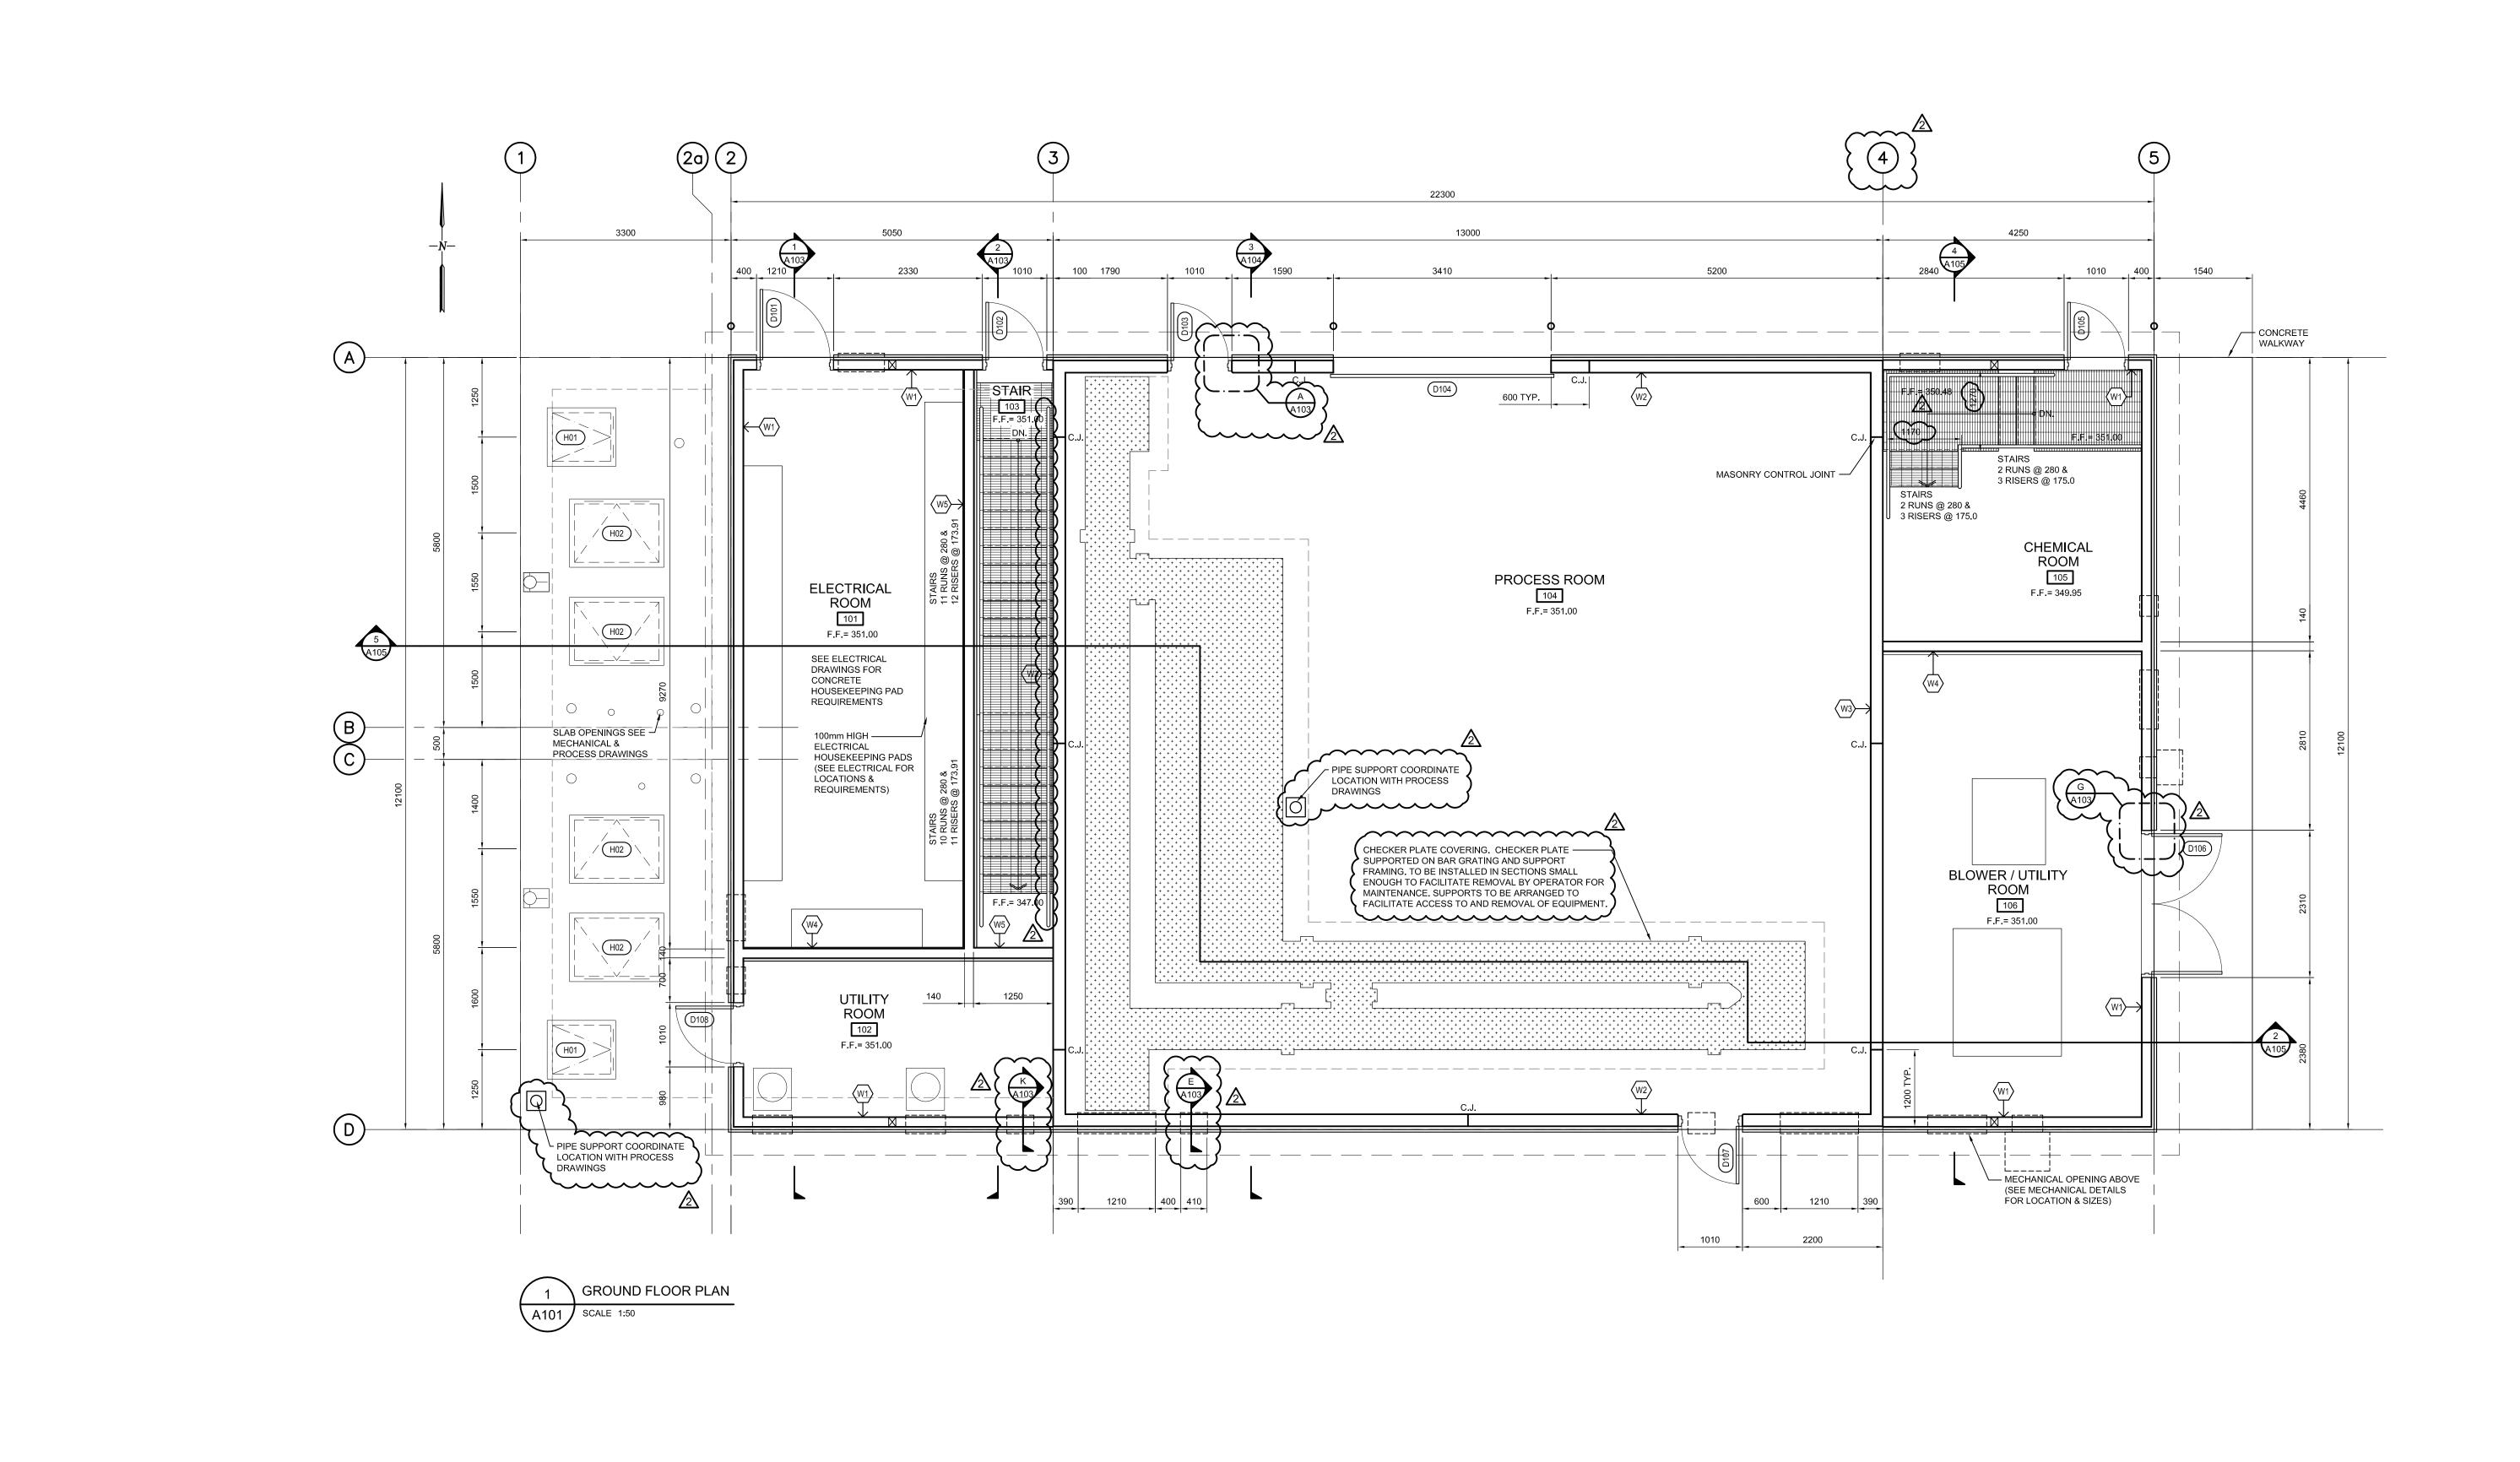

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FOR TENDER

or omissions to this office prior to construction.

2 ISSUED FOR

3 REVISED AS F

applicable to this project.

No.	Issue / Revision	Date
1	ISSUED FOR 90% REVIEW	OCT. 2015
2	ISSUED FOR TENDER	DEC. 2015
3	REVISED AS PER ADDENDUM NO. 2	JAN. 2016

SP M Hofe SI M. R. HOFER 100137122


BURNSIDE


R.J. Burnside & Associates Limited 292 Speedvale Ave. W., Unit 20 Guelph, Ontario, N1H 1C4 telephone (519) 823-4995 fax (519) 836-5477 web www.rjburnside.com

ALMA ST. WASTEWATER PRETREATMENT
FACILITY UPGRADES
ARCHITECTURAL
MAIN FLOOR PLAN

TOWNSHIP OF GUELPH / ERAMOSA


8348 WELLINGTON ROAD 124, P.O. BOX 700
ROCKWOOD, ON
N0B 2K0

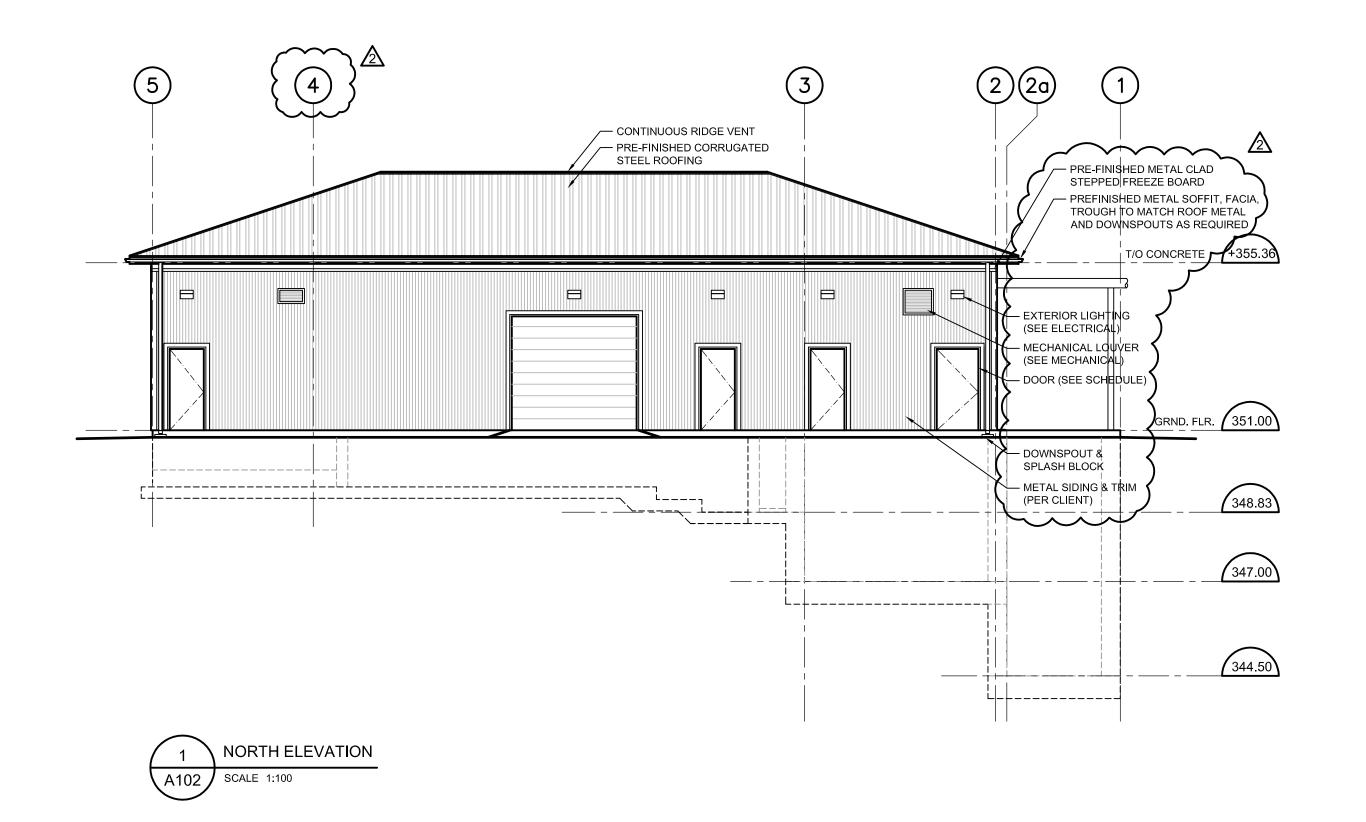


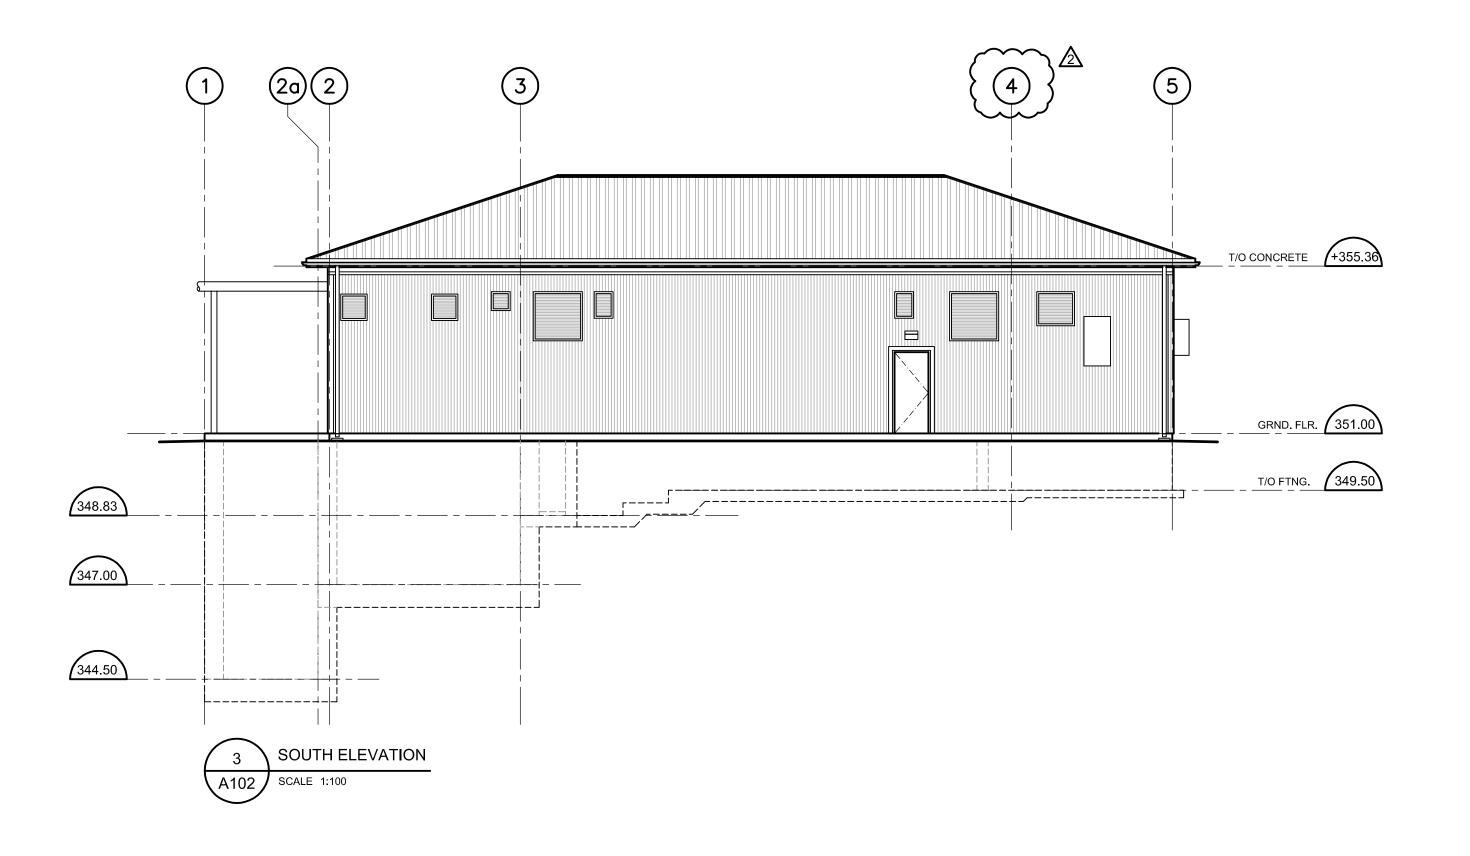

W. R. FOFER

100137122

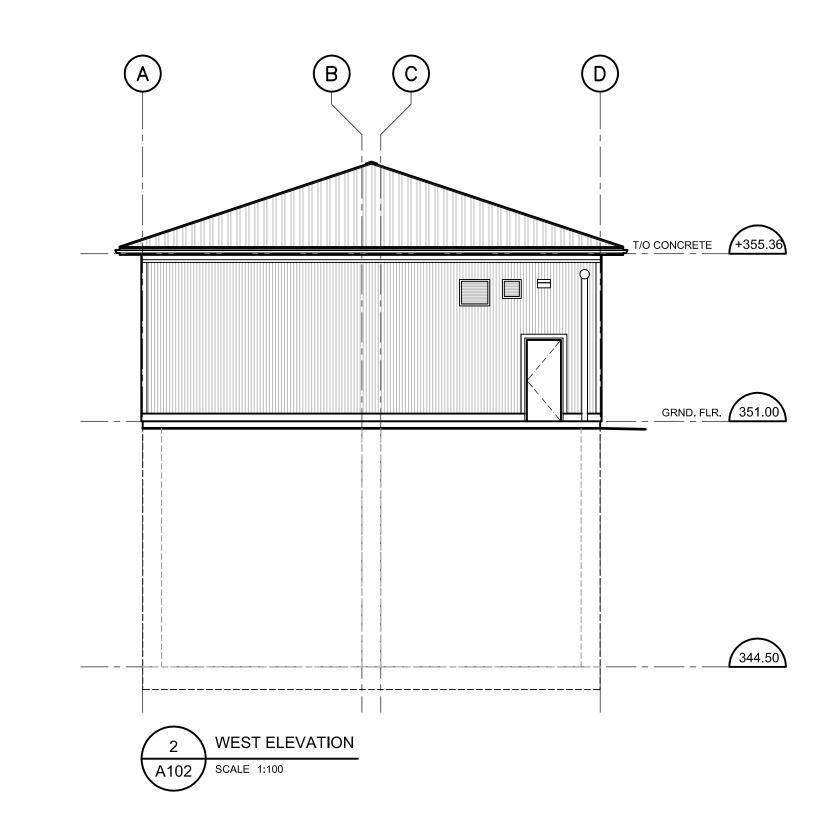

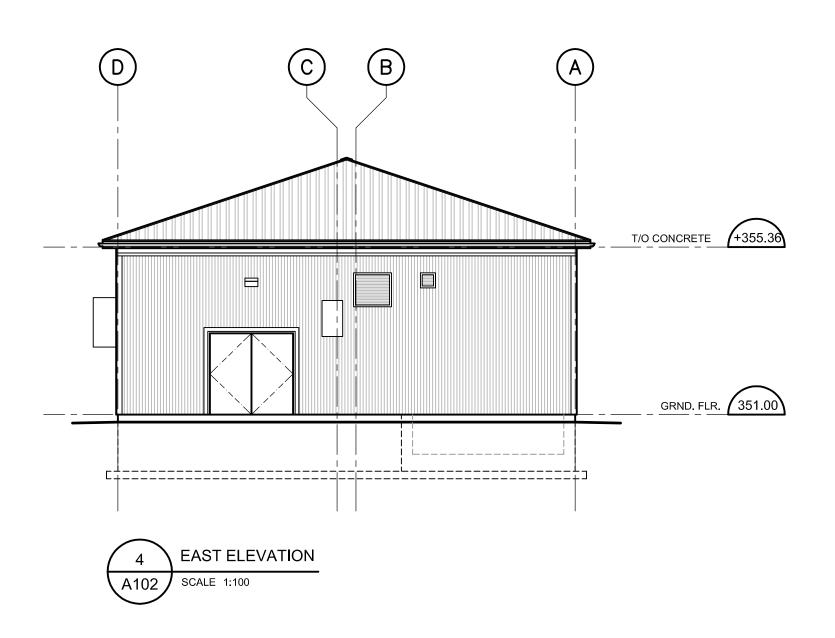

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 The contractor shall verify all dimensions, levels, and datums on site and report any discrepancies.

FOR TENDER

2. The contractor shall verify all dimensions, levels, and datums on site and report any discrepancies or omissions to this office prior to construction.

1 ISSUED FOR 90% REVIEW

2 ISSUED FOR TENDER

3 REVISED AS PER ADDENDUM NO. 2 JAN. 2

No. Issue / Revision Date

1 ISSUED FOR 90% REVIEW
2 ISSUED FOR TENDER
3 REVISED AS PER ADDENDUM NO. 2 AND JAN. 2016

BURNSIDE


R.J. Burnside & Associates Limited 292 Speedvale Ave. W., Unit 20 Guelph, Ontario, N1H 1C4 telephone (519) 823-4995 fax (519) 835-5477


web www.rjburnside.com


Drawing Title
ALMA ST. WASTEWATER PRETREATMENT
FACILITY UPGRADES
ARCHITECTURAL
ELEVATIONS

TOWNSHIP OF GUELPH / ERAMOSA

8348 WELLINGTON ROAD 124, P.O. BOX 700
ROCKWOOD, ON
N0B 2K0

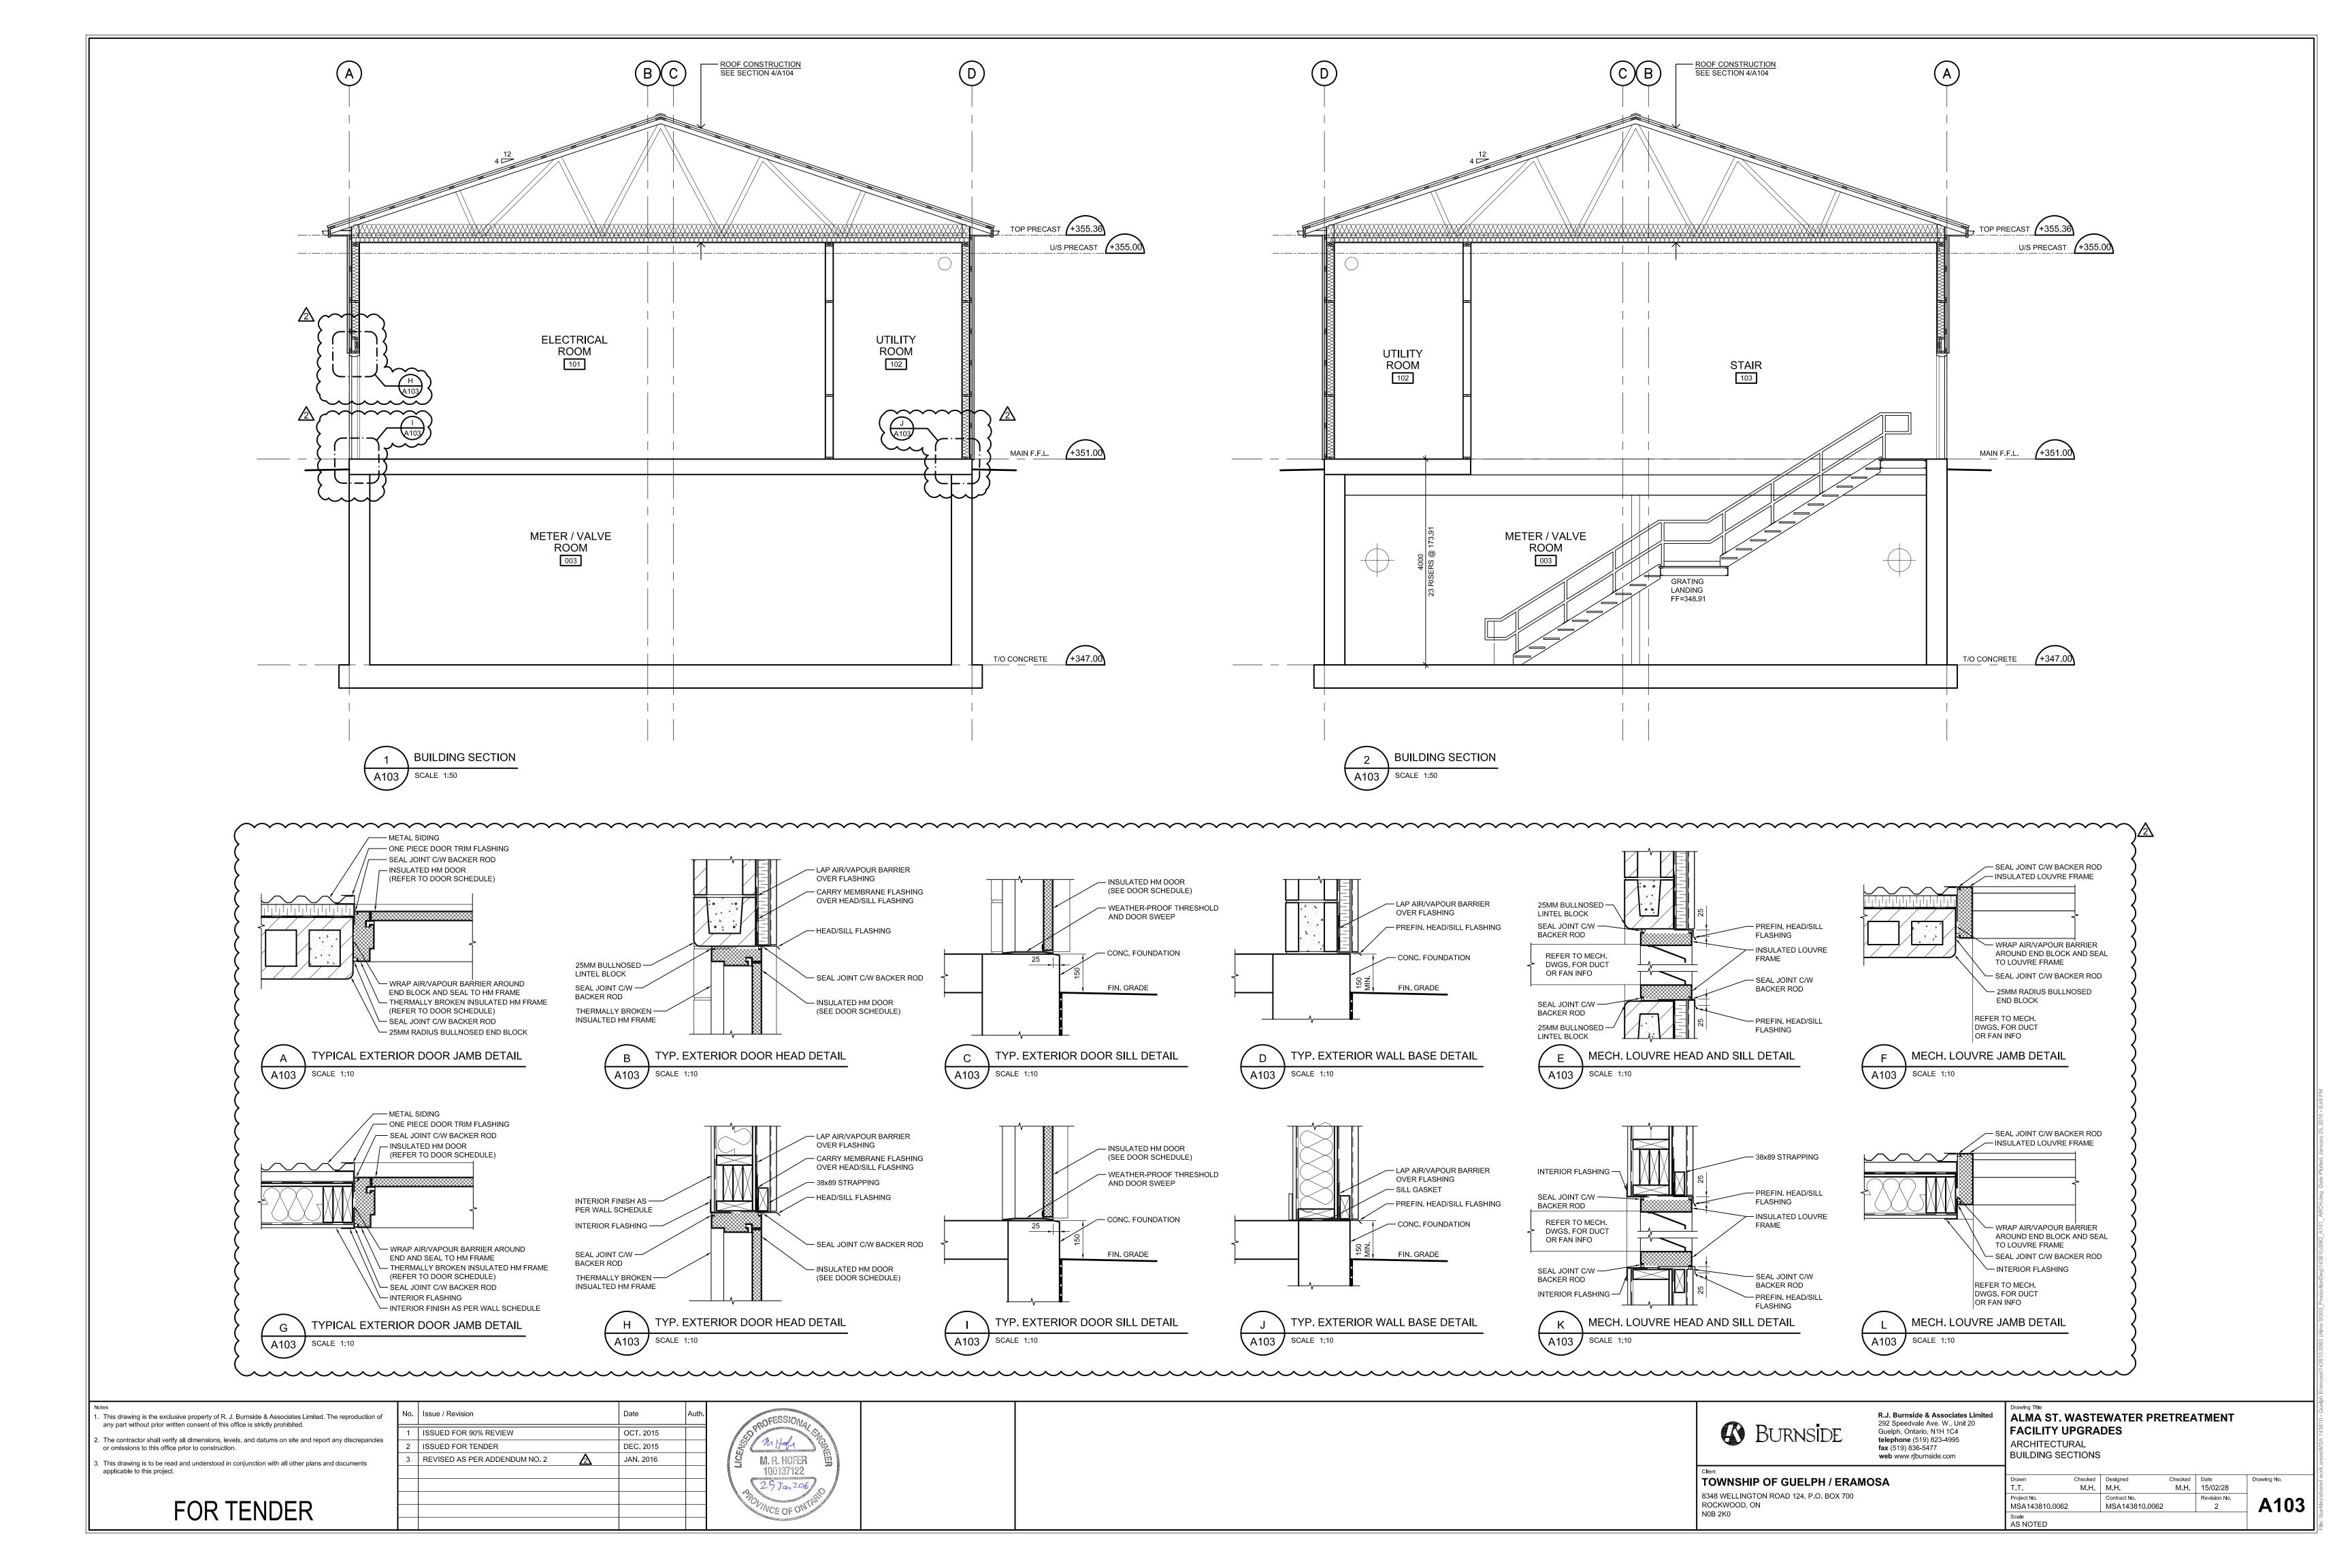

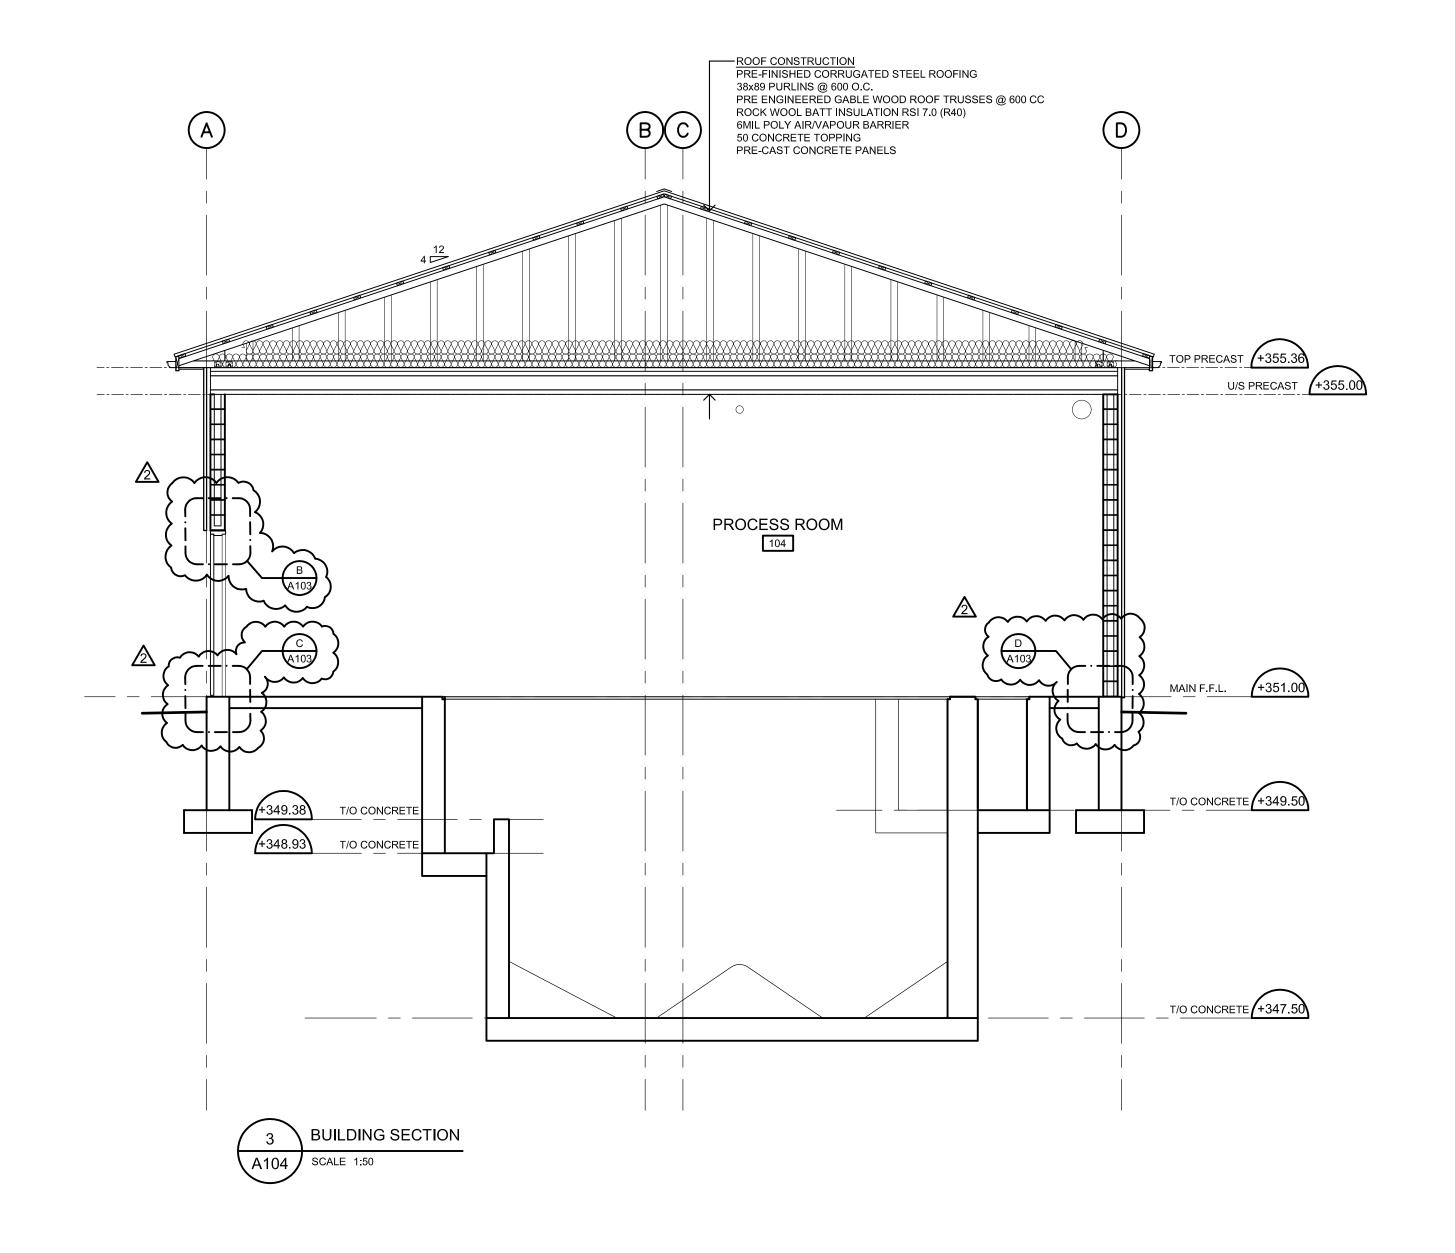

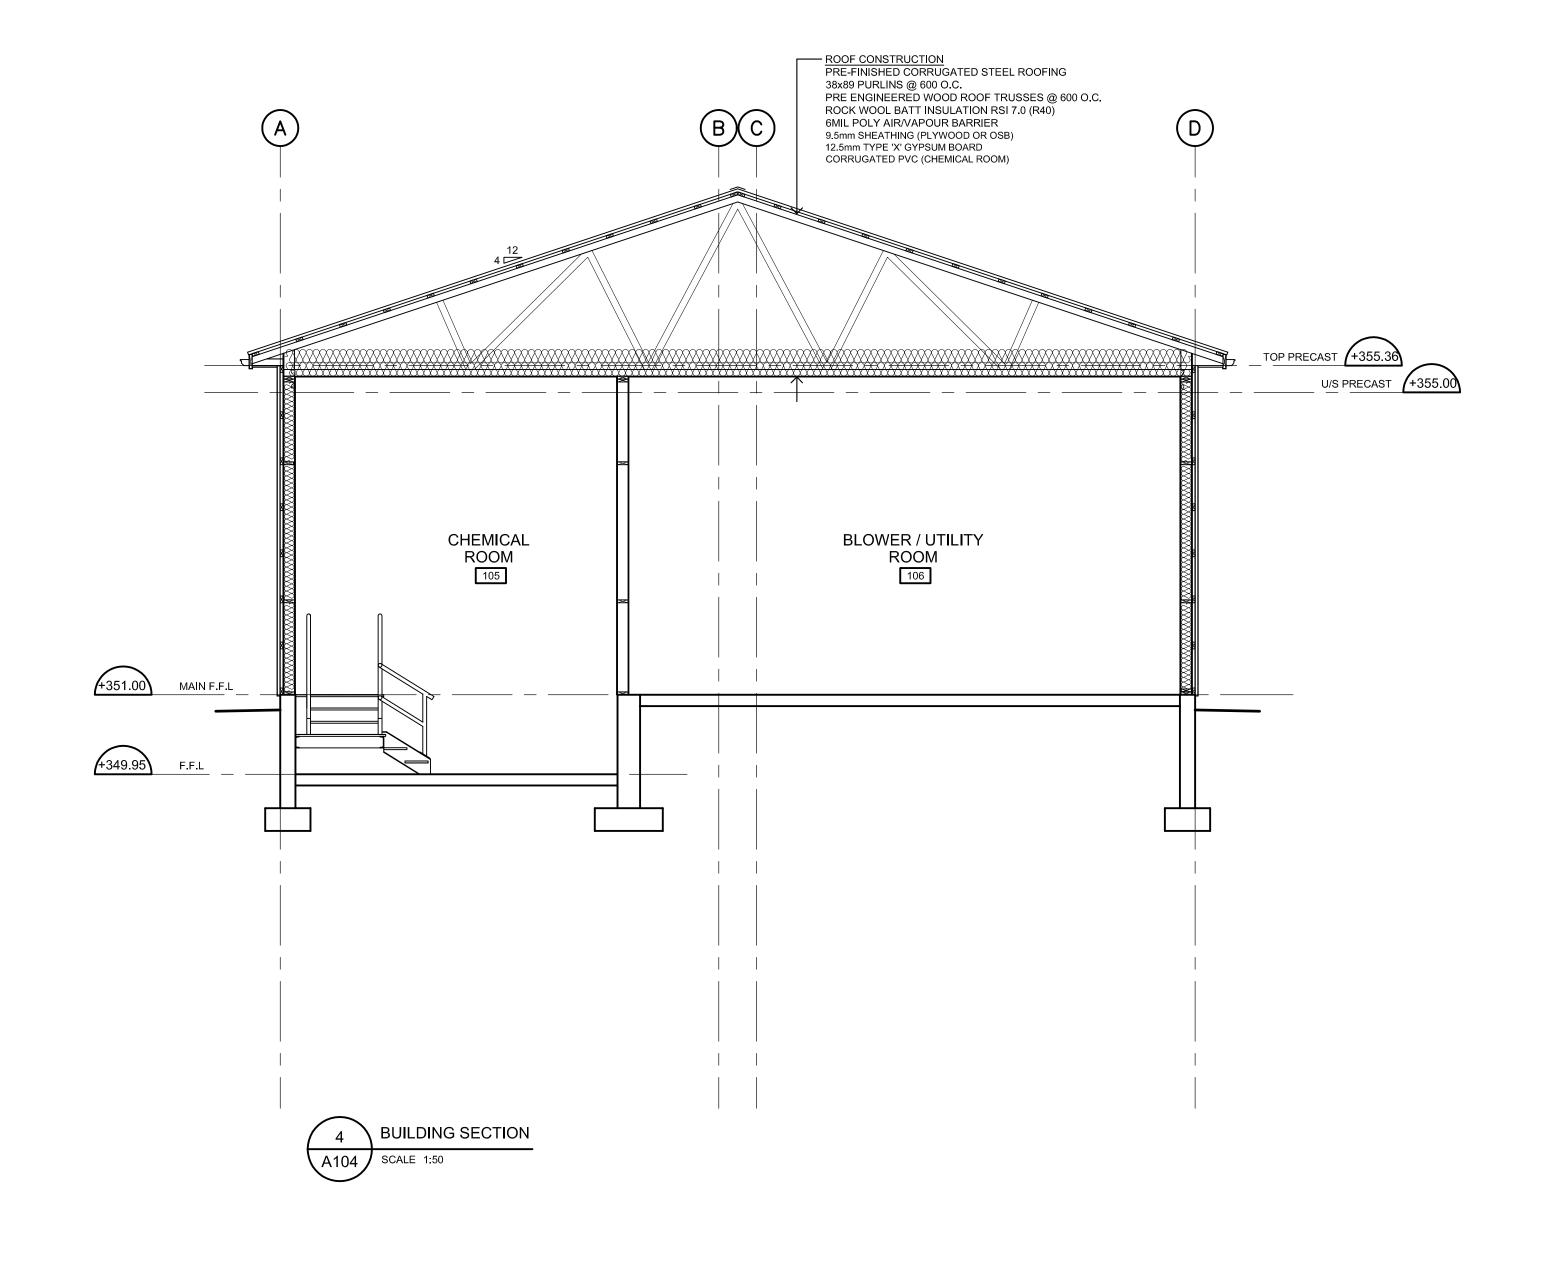

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П	

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No.	Issue / Revision	Date	Au
1	ISSUED FOR 90% REVIEW	OCT. 2015	
2	ISSUED FOR TENDER	DEC. 2015	
3	REVISED AS PER ADDENDUM NO. 2	JAN. 2016	
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E MHL
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25 Jan 2016
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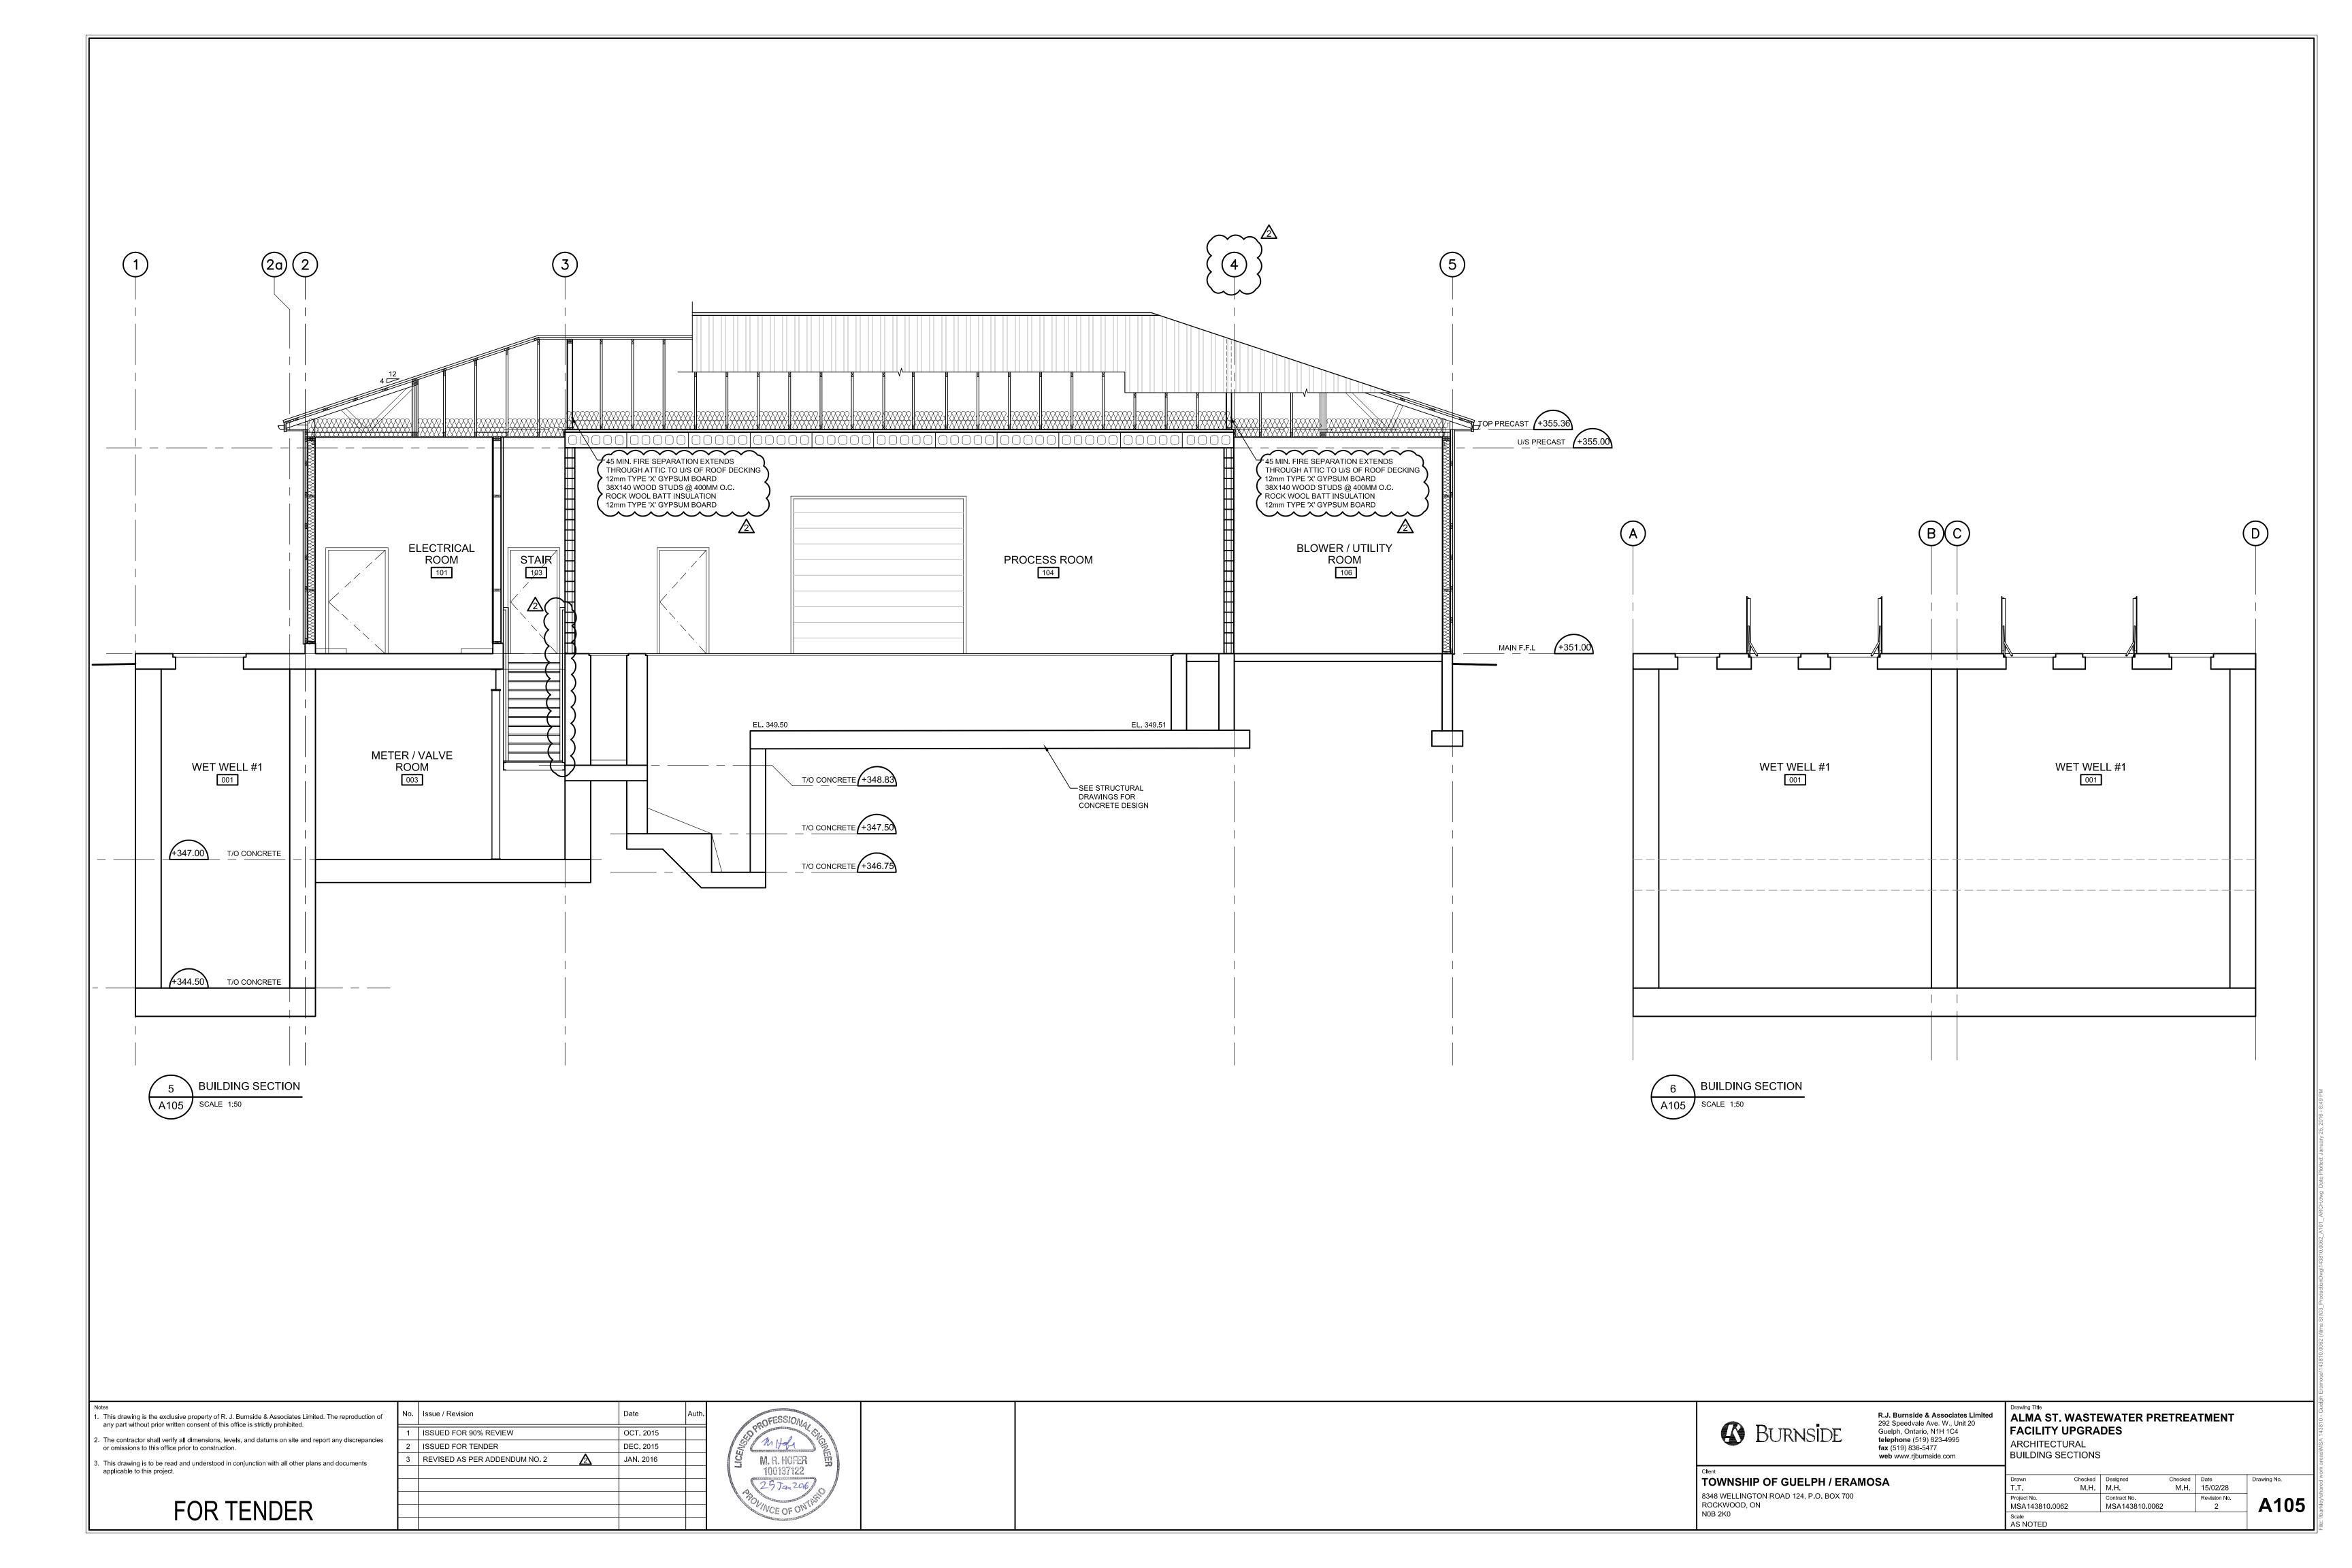
R.J. Burnside & Associates Limited 292 Speedvale Ave. W., Unit 20 Guelph, Ontario, N1H 1C4 telephone (519) 823-4995 fax (519) 836-5477 web www.rjburnside.com


ALMA ST. WASTEWATER PRETREATMENT FACILITY UPGRADES ARCHITECTURAL BUILDING SECTIONS


TOWNSHIP OF GUELPH / ERAMOSA 8348 WELLINGTON ROAD 124, P.O. BOX 700 ROCKWOOD, ON N0B 2K0


Checked Date
M.H. 15/02/28 M.H. M.H. Project No. MSA143810.0062 Contract No. MSA143810.0062 A104 Scale AS NOTED


^{3.} This drawing is to be read and understood in conjunction with all other plans and documents applicable to this project.




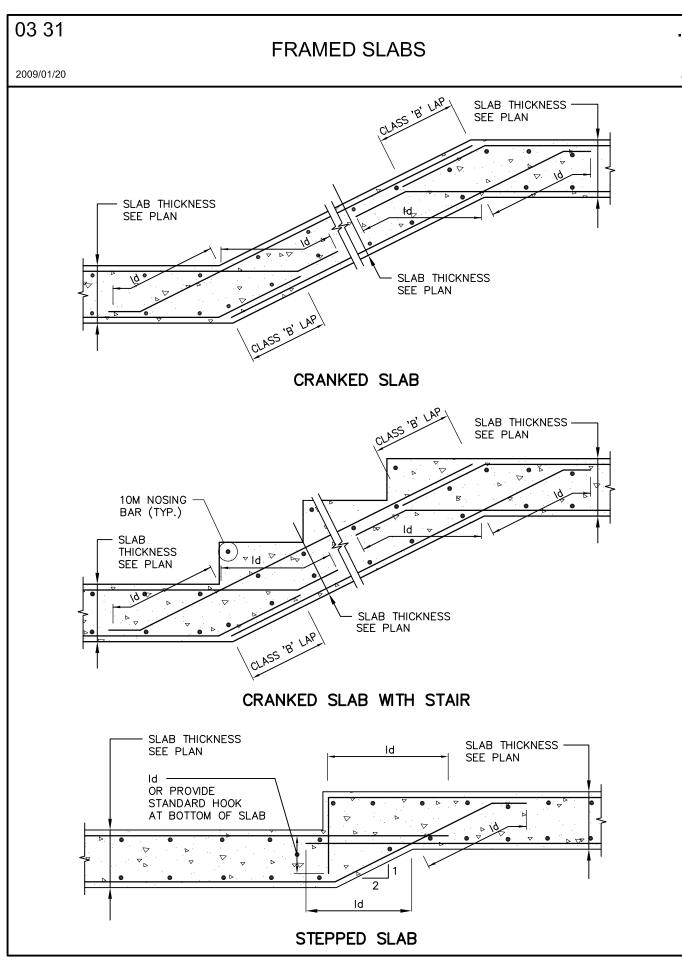


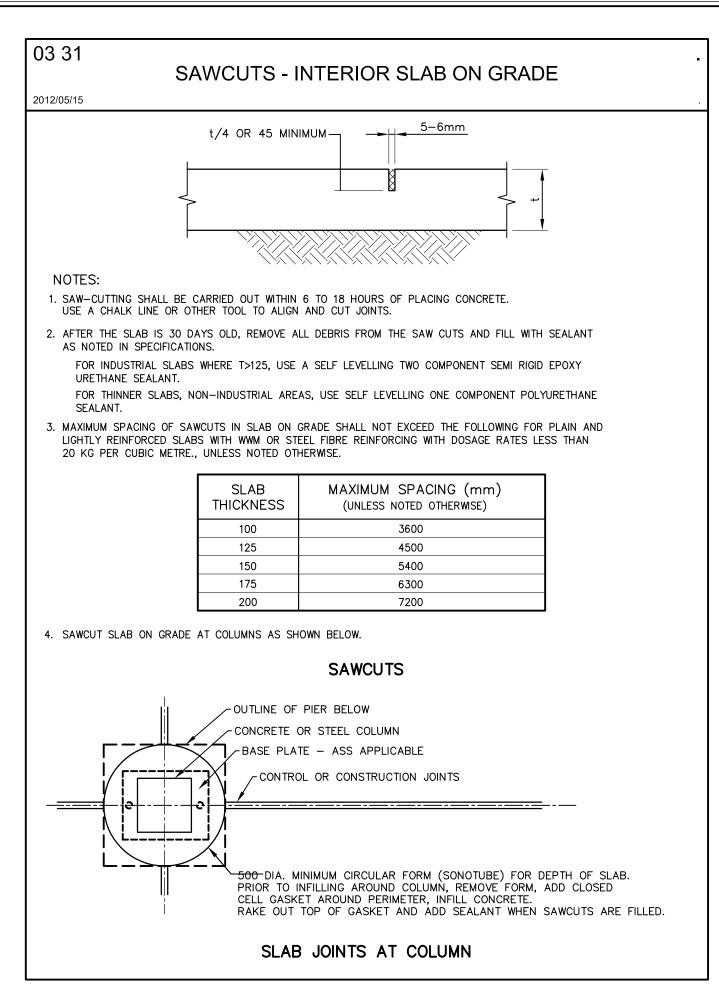


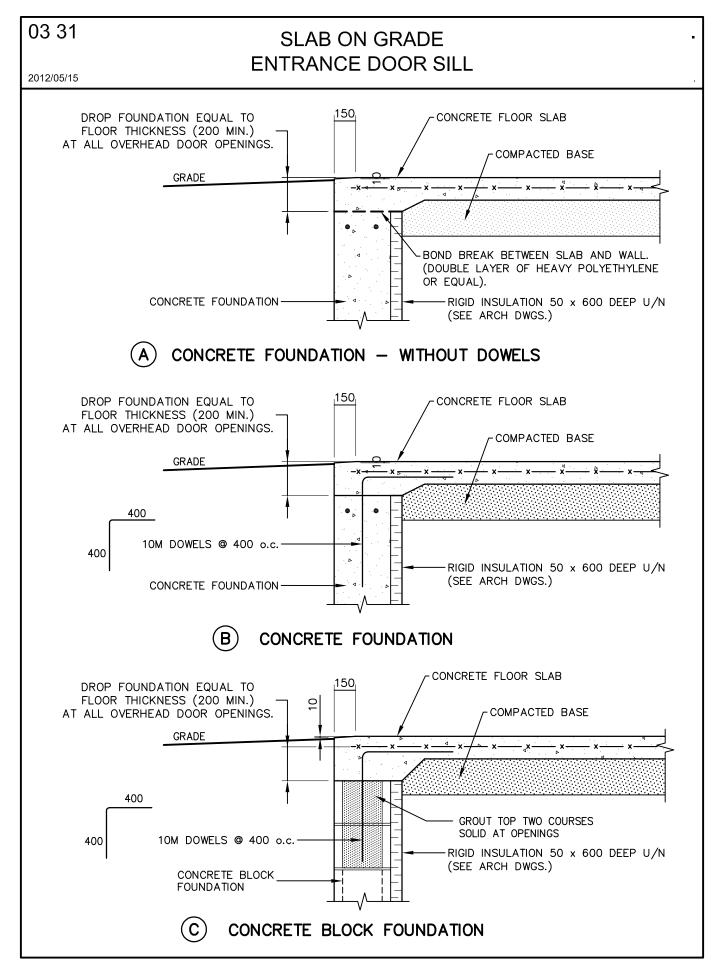


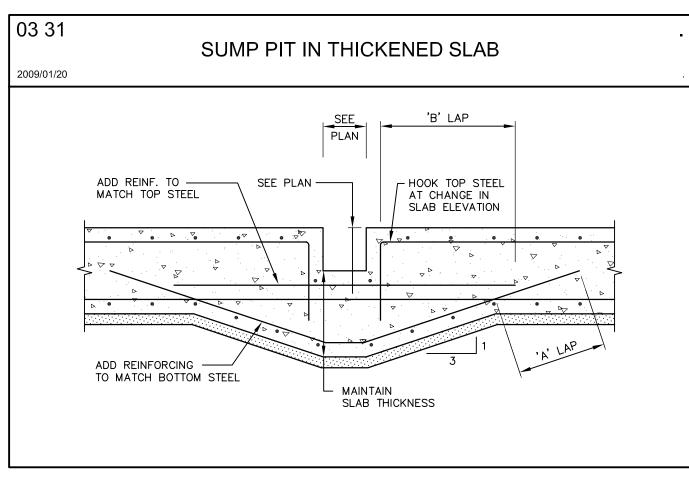


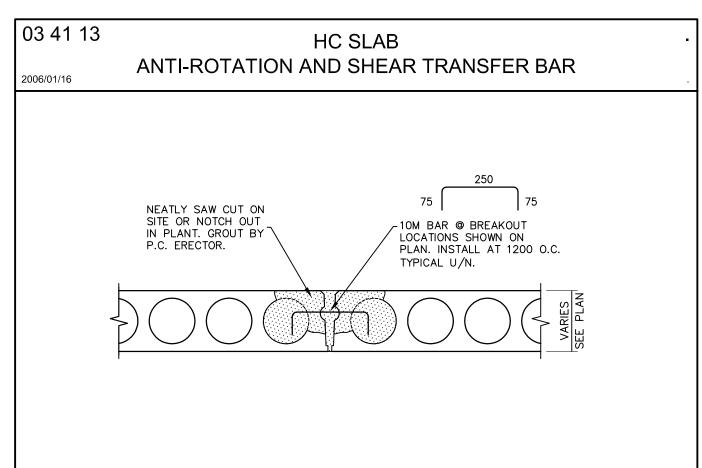

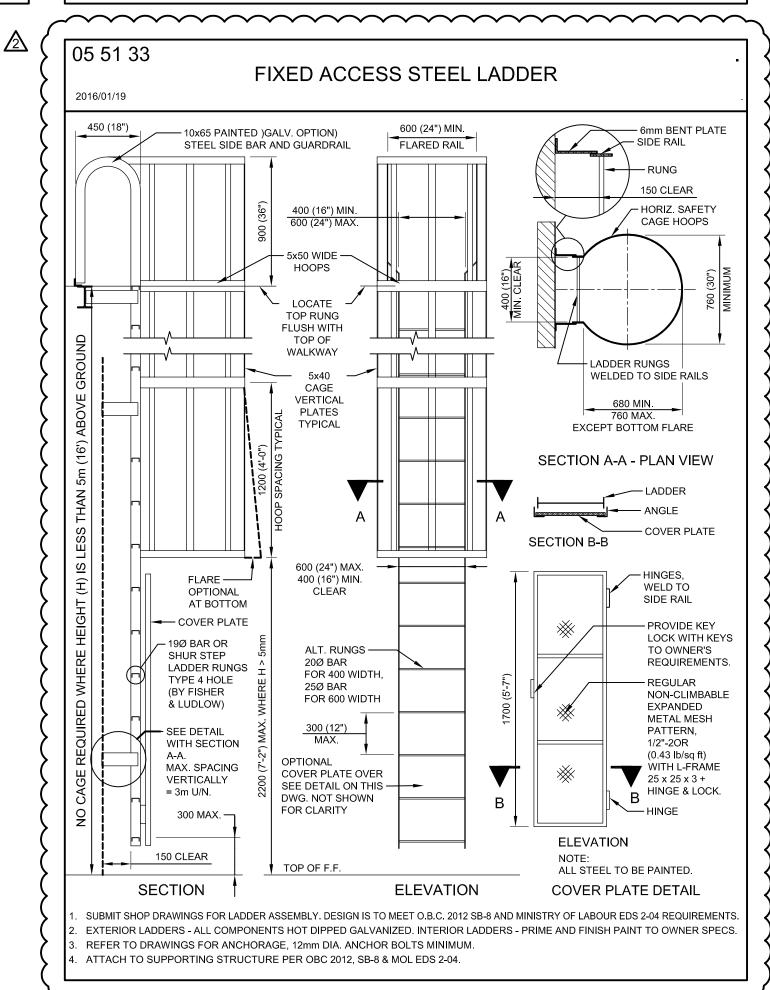

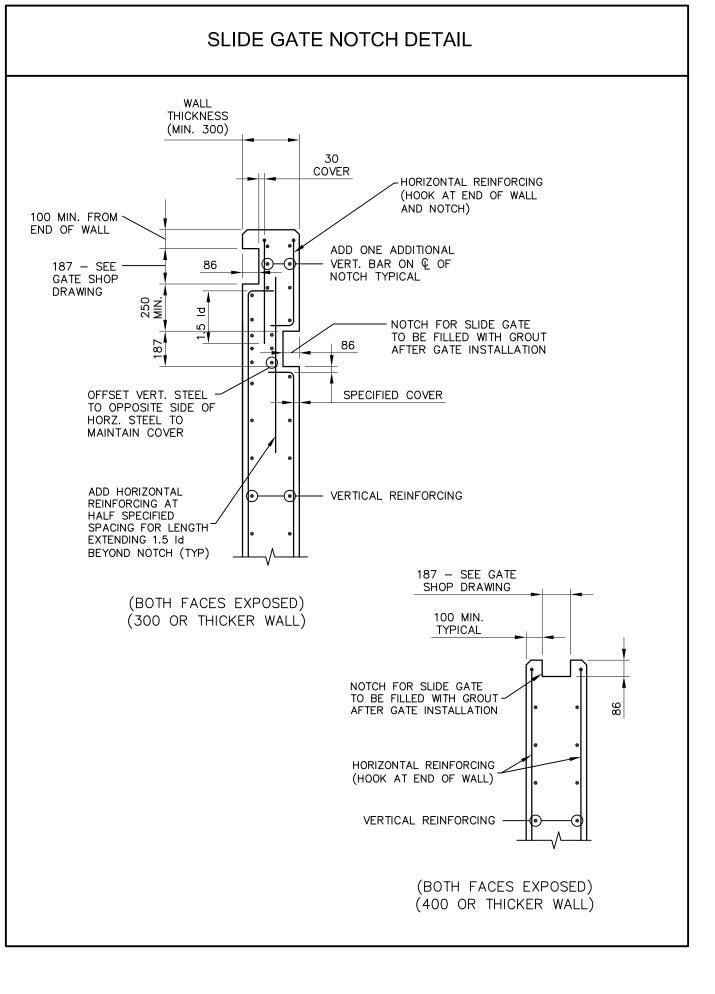

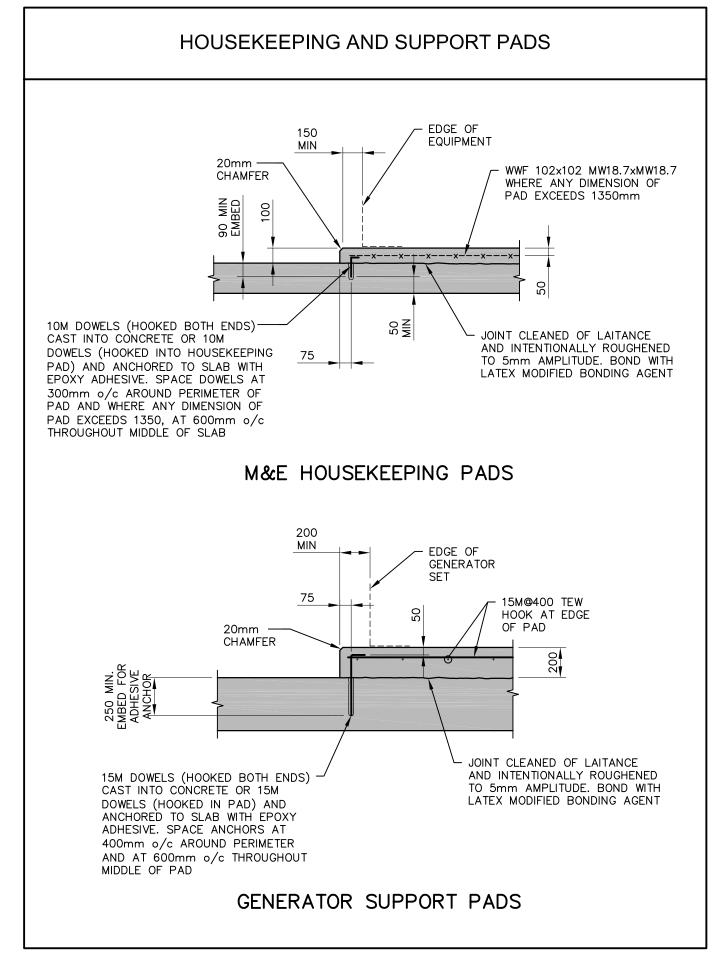


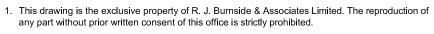


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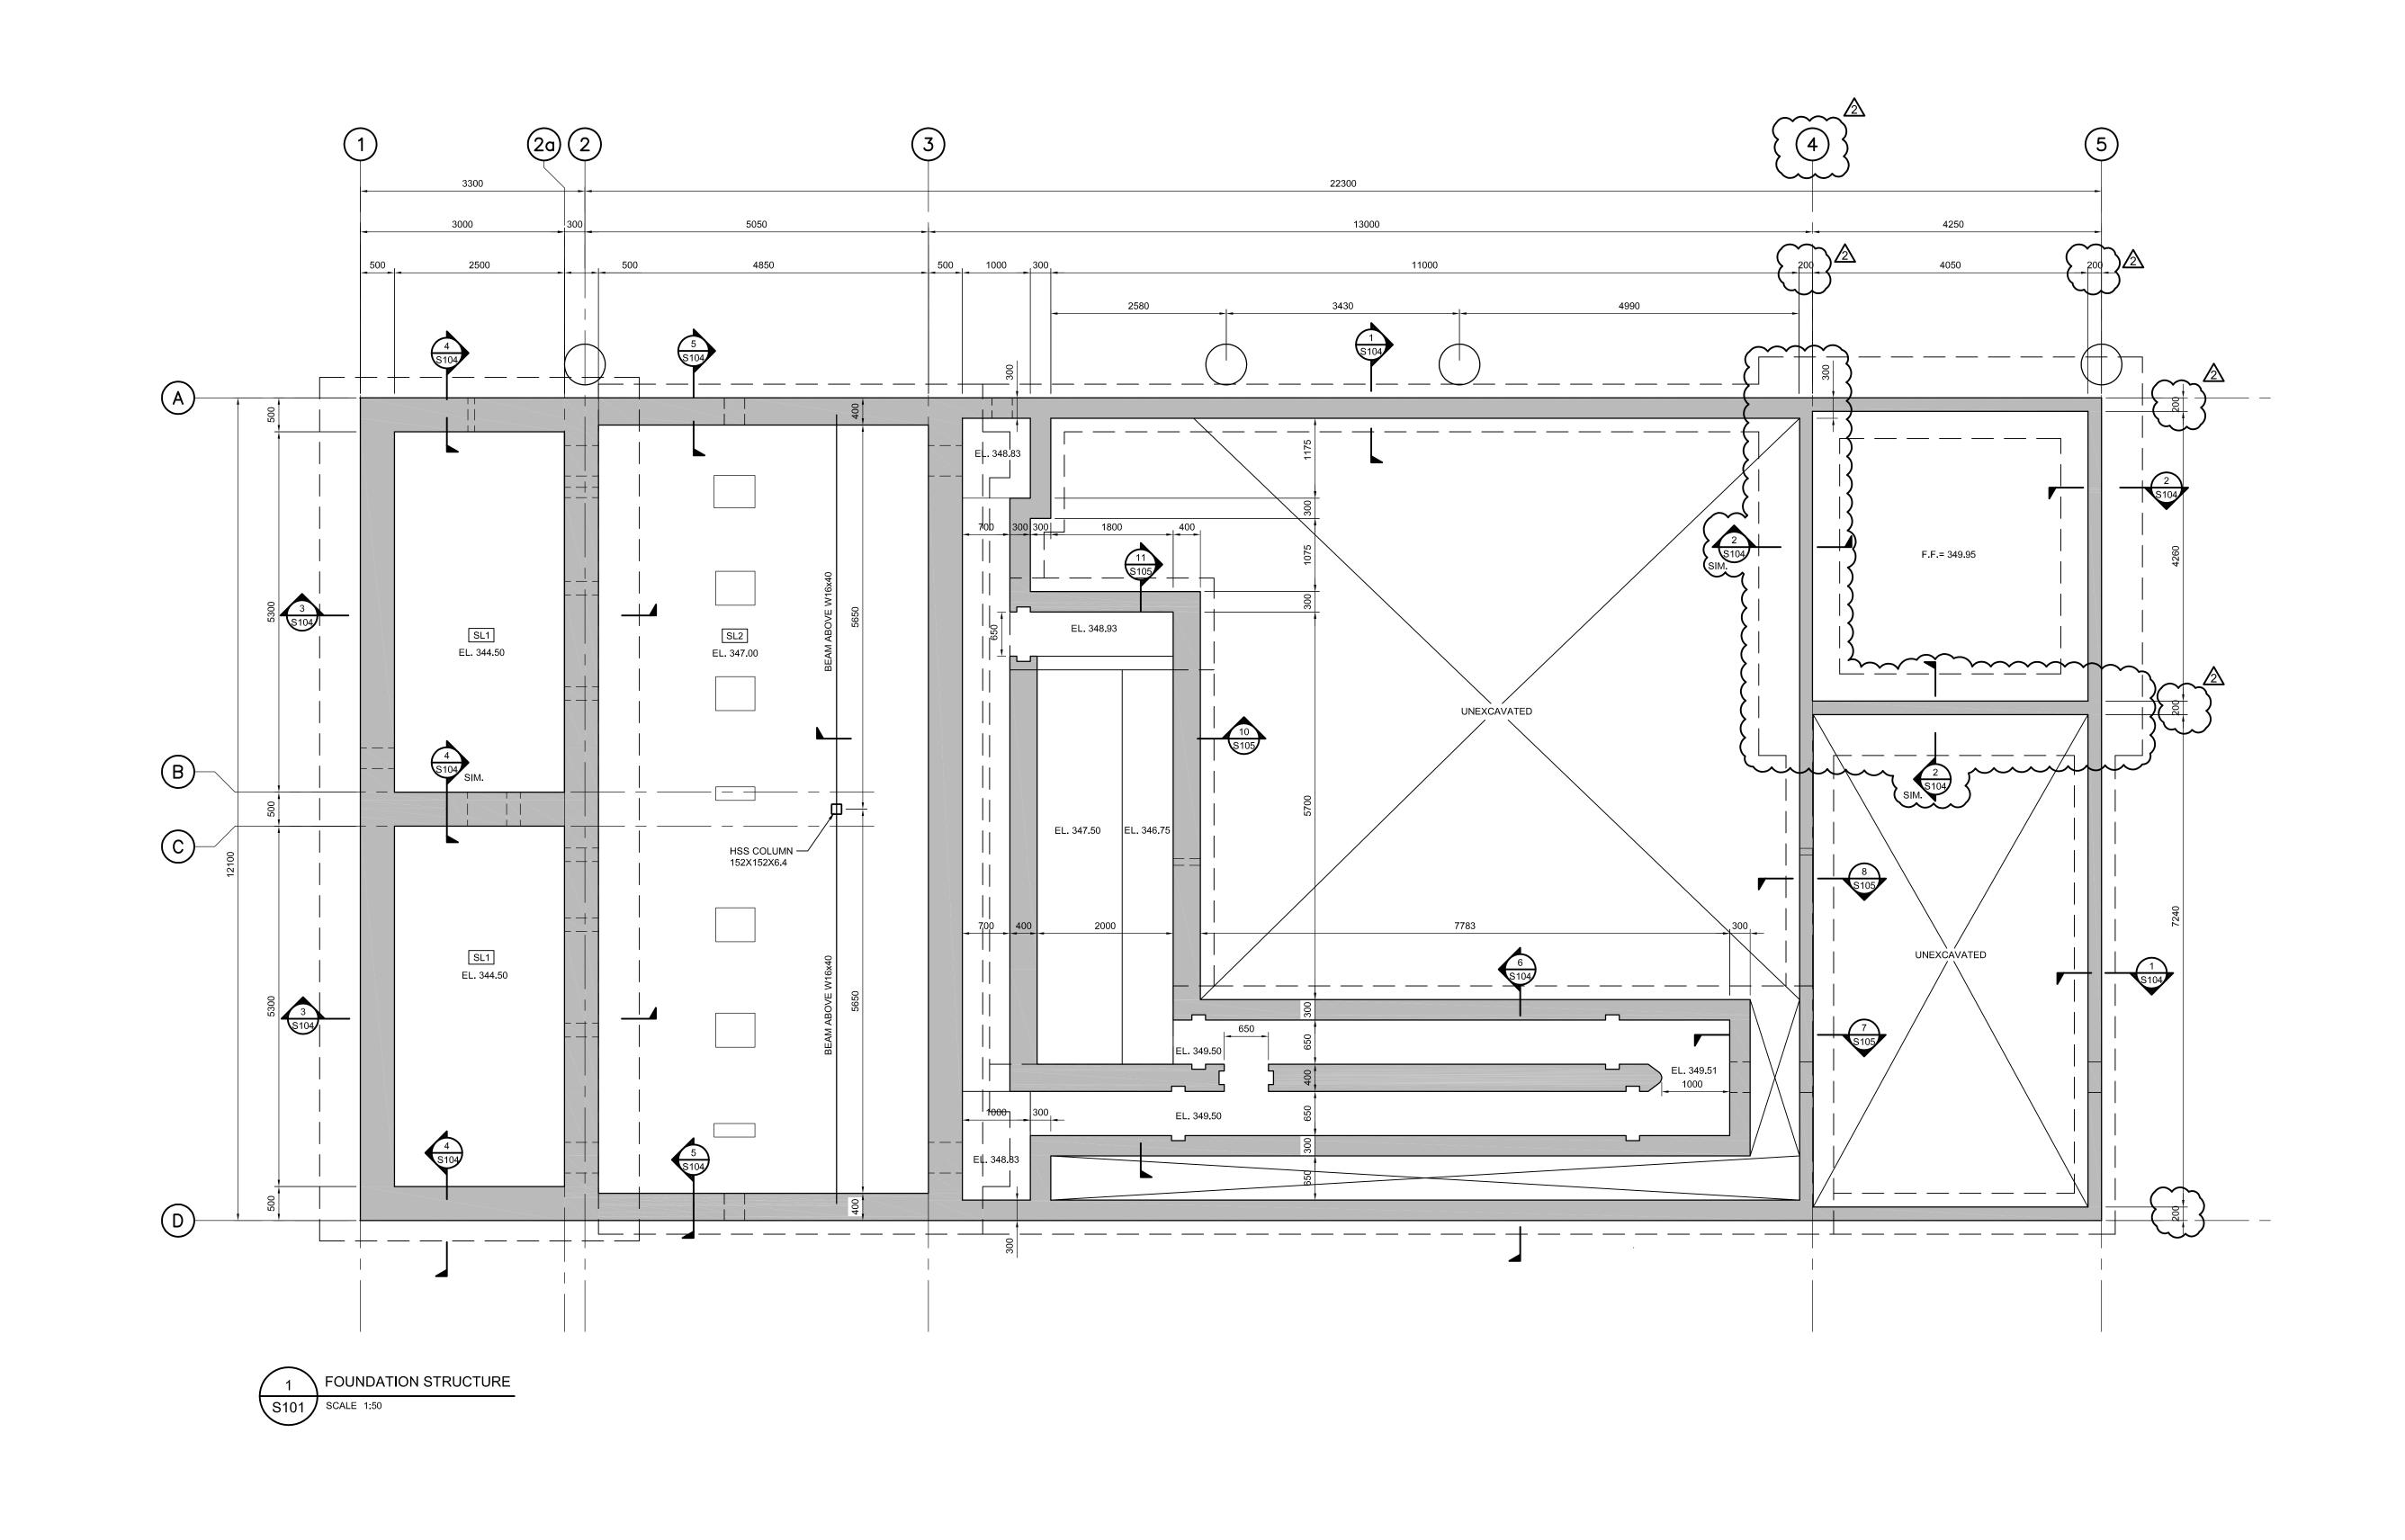
R.J. Burnside & Associates Limited 292 Speedvale Ave. W., Unit 20 Guelph, Ontario, N1H 1C4 telephone (519) 823-4995 fax (519) 836-5477 web www.rjburnside.com

ALMA ST. WASTEWATER PRETREATMENT FACILITY UPGRADES
STRUCTURAL TYPICAL DETAILS

TOWNSHIP OF GUELPH / ERAMOSA

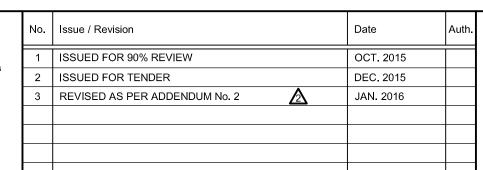8348 WELLINGTON ROAD 124, P.O. BOX 700
ROCKWOOD, ON

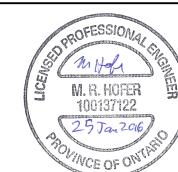N0B 2K0



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2. The contractor shall verify all dimensions, levels, and datums or omissions to this office prior to construction. This drawing is to be read and understood in conjunction with al applicable to this project.


exclusive property of R. J. Burnside & Associates Limited. The reproduction of ior written consent of this office is strictly prohibited. Il verify all dimensions, levels, and datums on site and report any discrepancies office prior to construction.		Issue / Revision	Date
		ISSUED FOR 90% REVIEW	OCT. 2015
		ISSUED FOR TENDER	DEC. 2015
be read and understood in conjunction with all other plans and documents coject.		REVISED AS PER ADDENDUM NO. 2	JAN. 2016
FOR TENDER			

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8348 WELLINGTON ROAD 124, P.O. BOX 700 ROCKWOOD, ON N0B 2K0

STRUCTURAL FOUNDATION PLAN TOWNSHIP OF GUELPH / ERAMOSA

Checked Date
M.H 15/02/28 Checked Designed M.H. M.H. Project No. MSA143810.0062 Contract No. MSA143810.0062 **S101** Scale AS NOTED

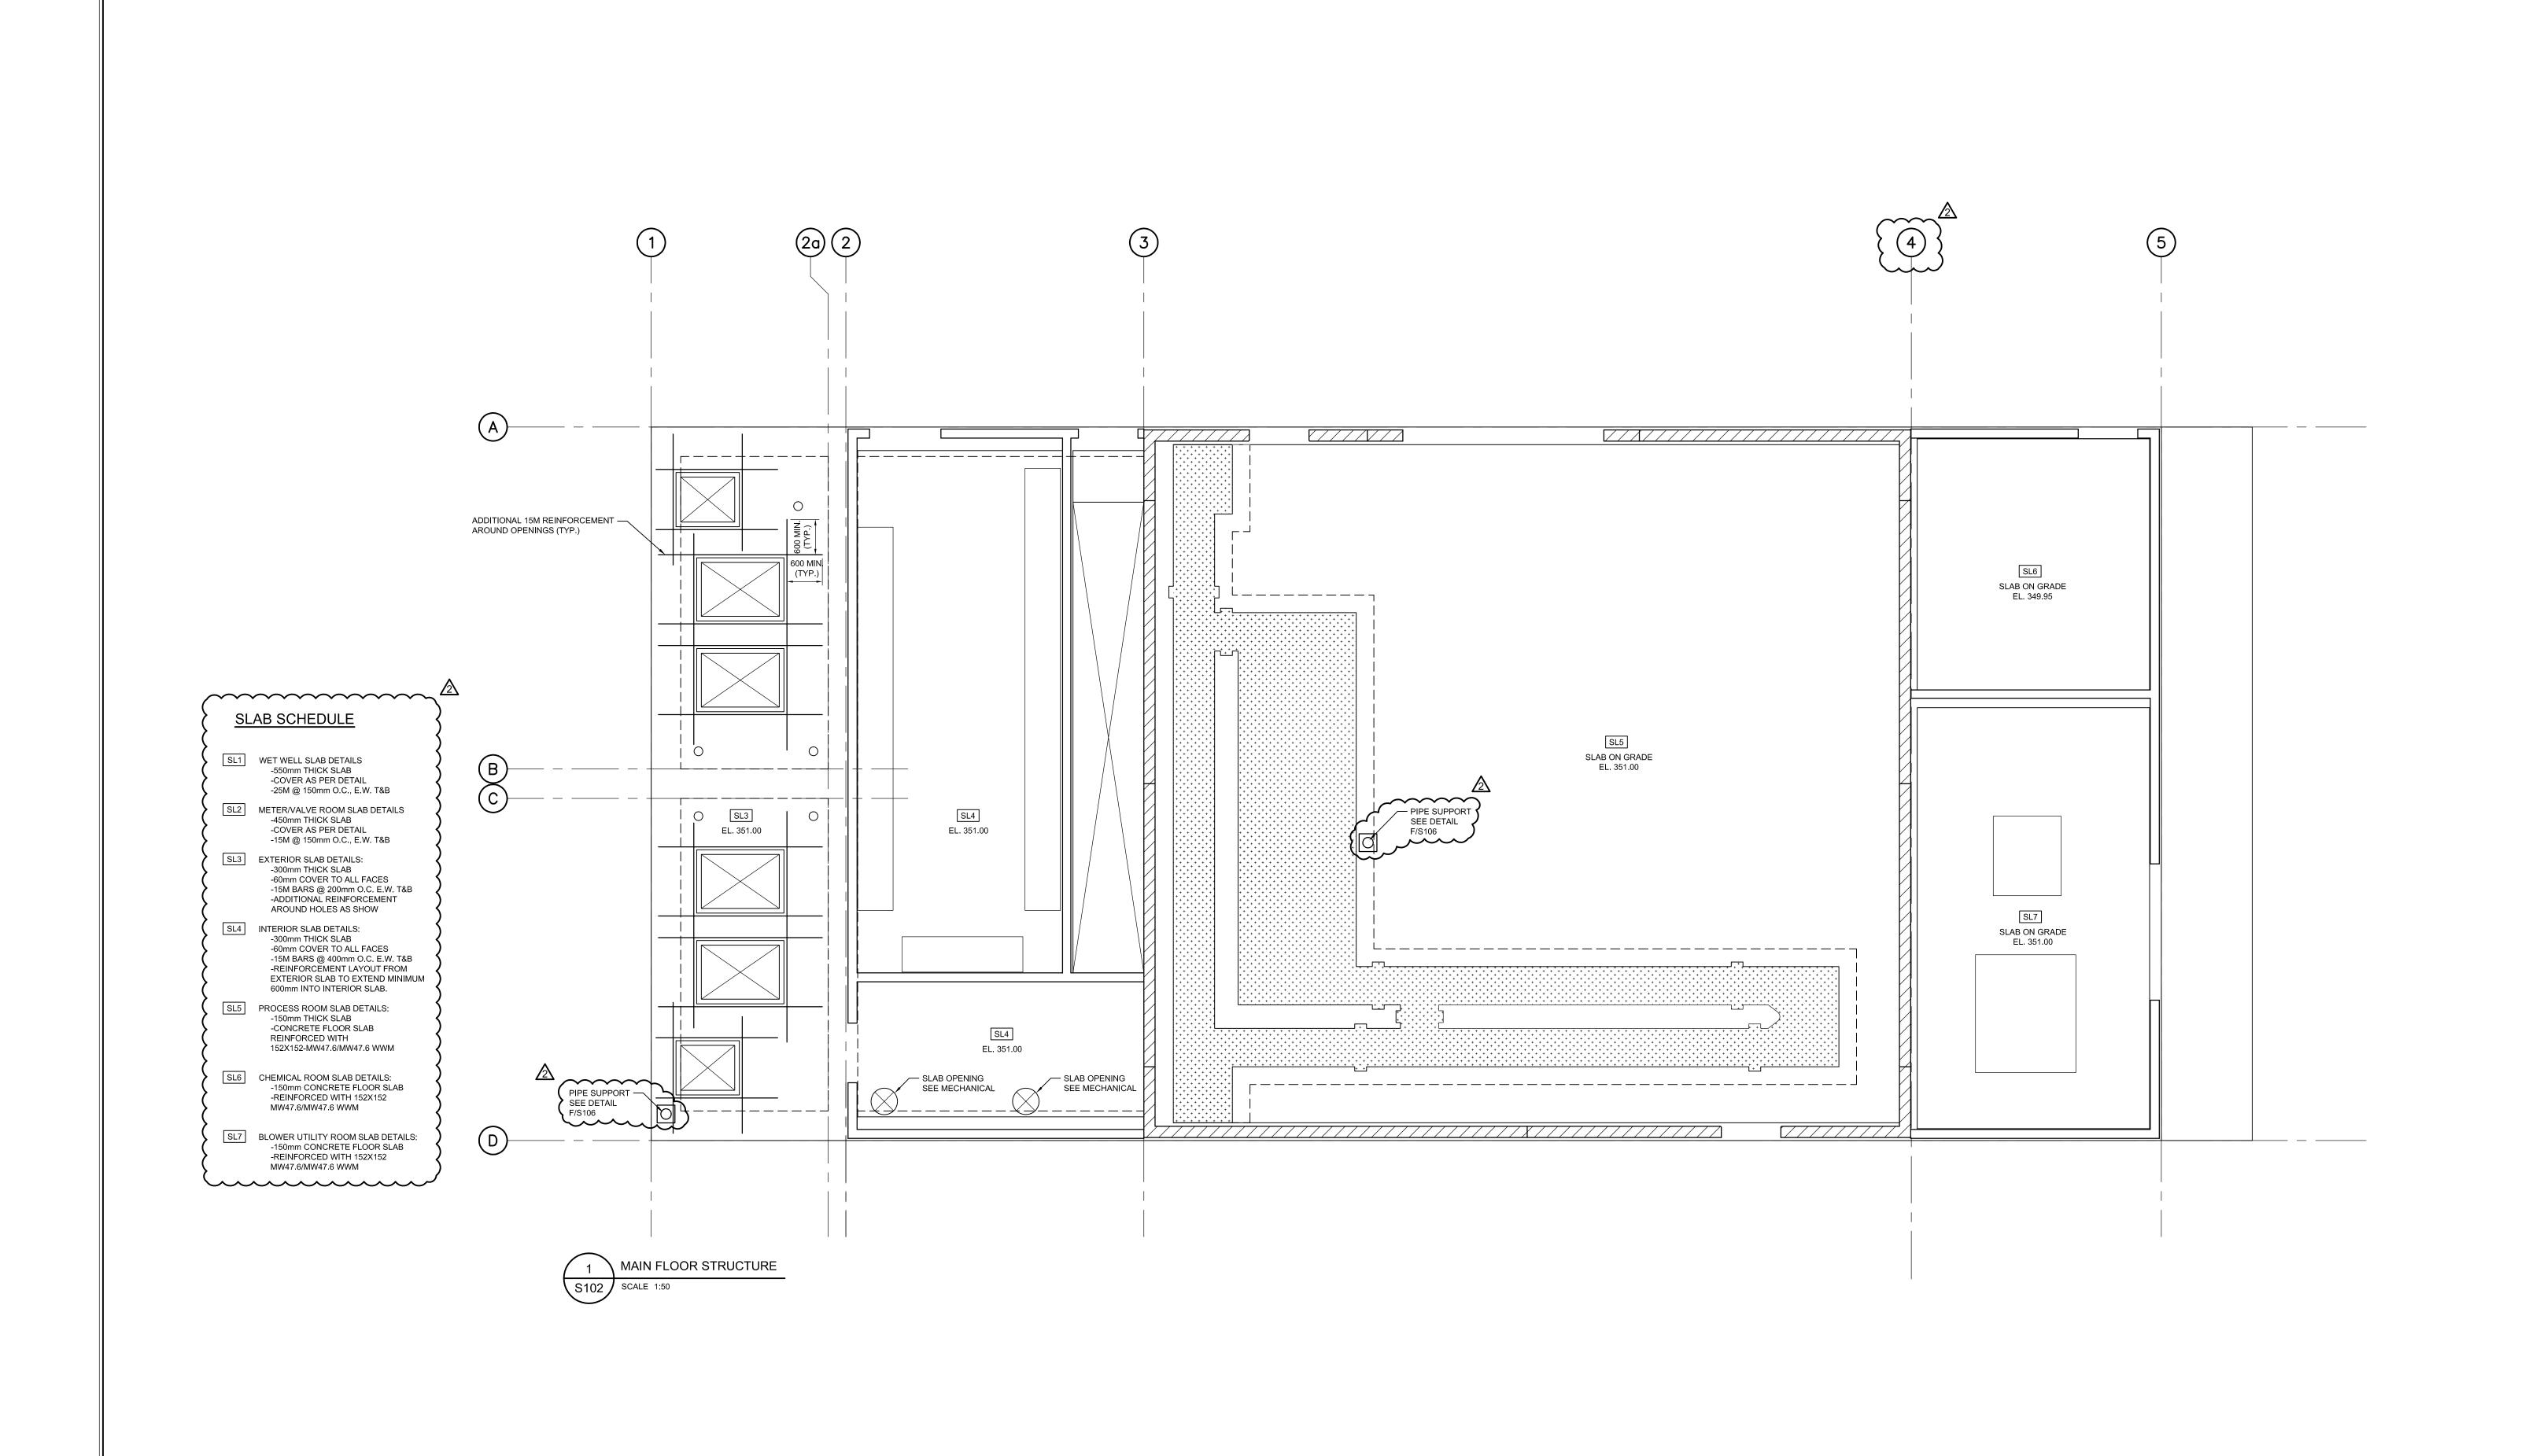

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No.	Issue / Revision	Date	F
1	ISSUED FOR 90% REVIEW	OCT. 2015	
2	ISSUED FOR TENDER	DEC. 2015	
3	REVISED AS PER ADDENDUM NO. 2	JAN. 2016	
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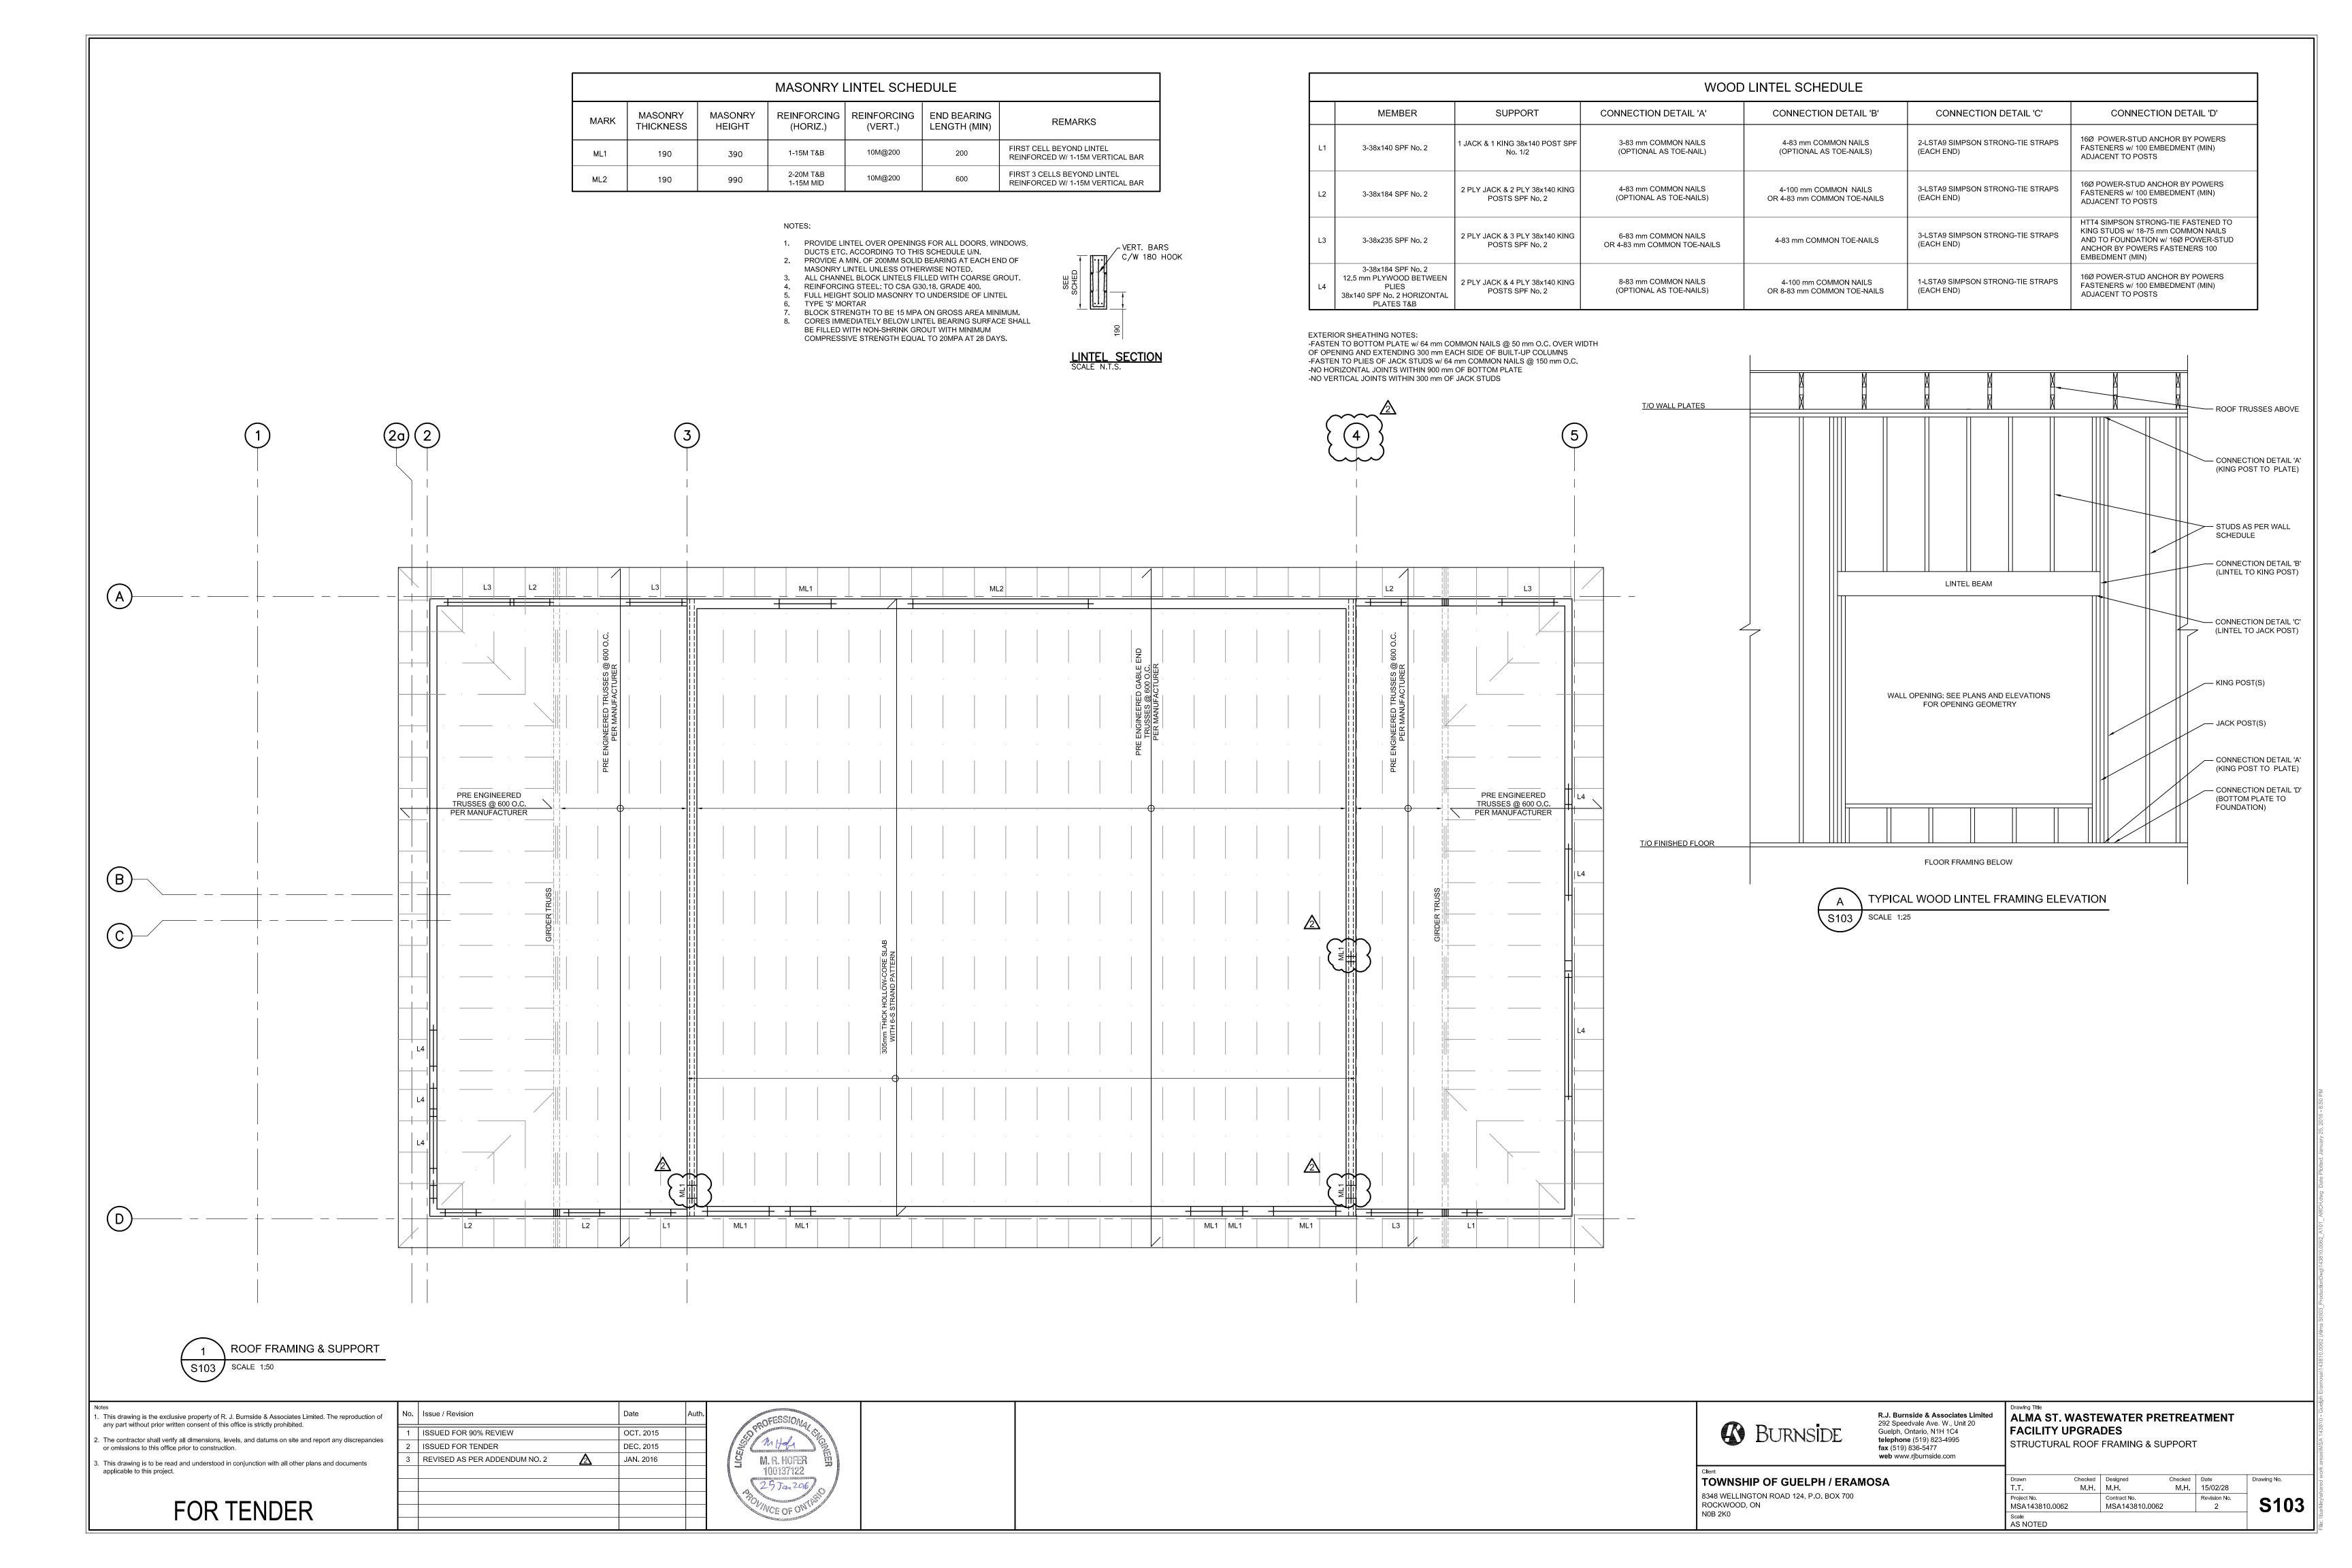
R.J. Burnside & Associates Limited 292 Speedvale Ave. W., Unit 20 Guelph, Ontario, N1H 1C4 telephone (519) 823-4995 fax (519) 836-5477 web www.rjburnside.com


ALMA ST. WASTEWATER PRETREATMENT FACILITY UPGRADES
STRUCTURAL MAIN FLOOR
FRAMING & SUPPORT


Scale AS NOTED

TOWNSHIP OF GUELPH / ERAMOSA

8348 WELLINGTON ROAD 124, P.O. BOX 700
ROCKWOOD, ON
N0B 2K0




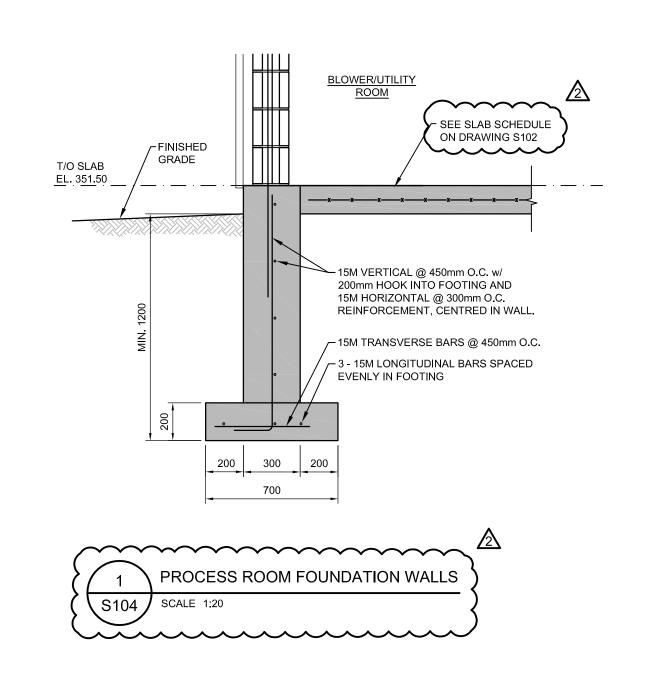


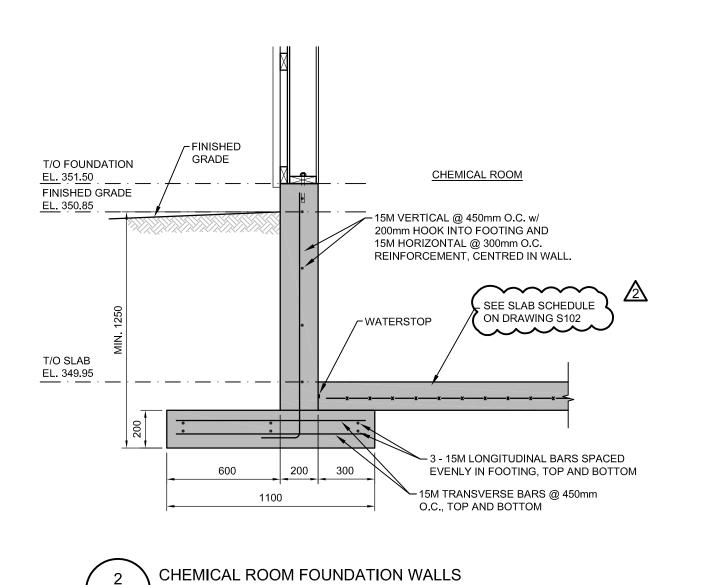


S104


SCALE 1:20

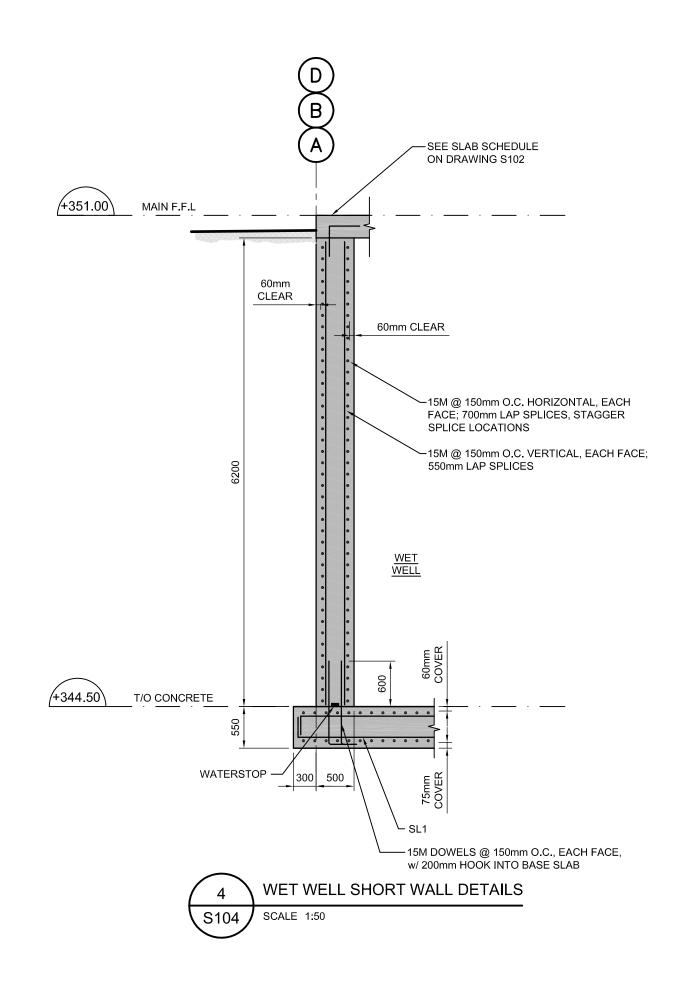

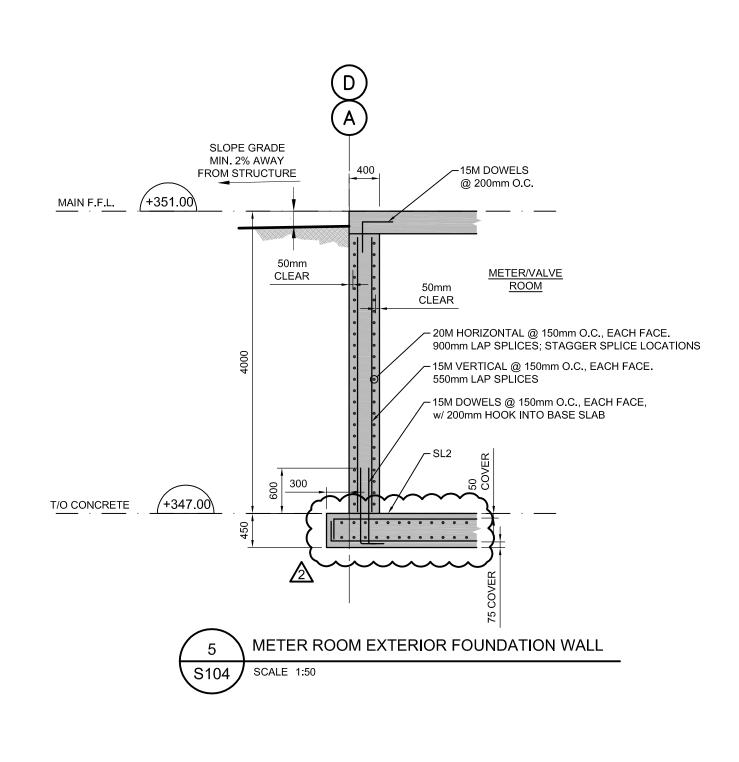

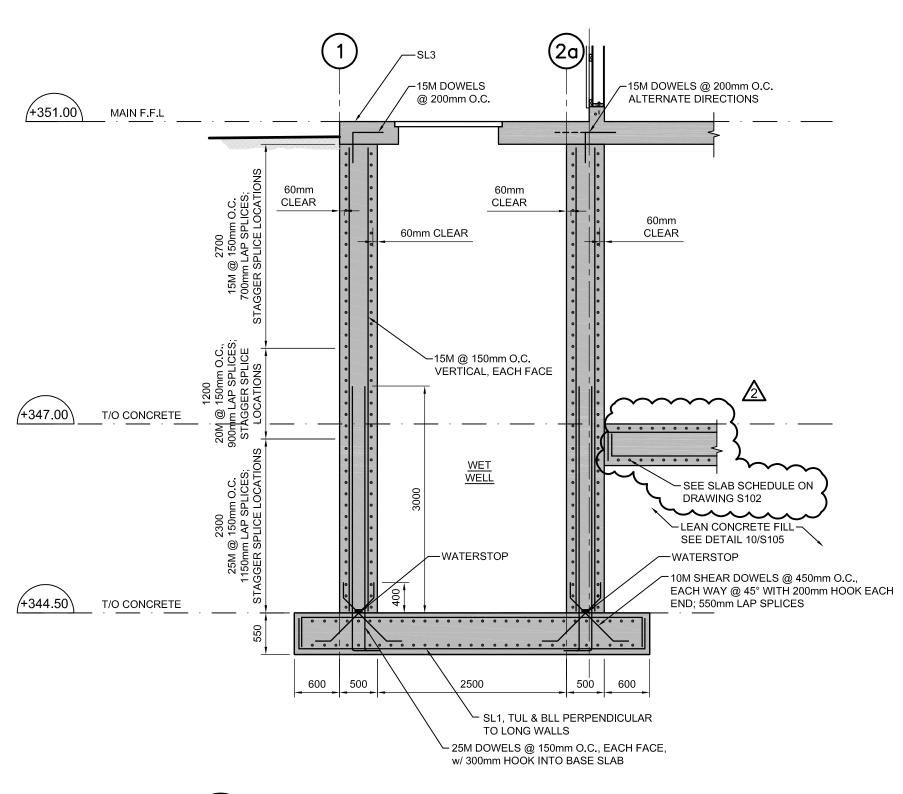



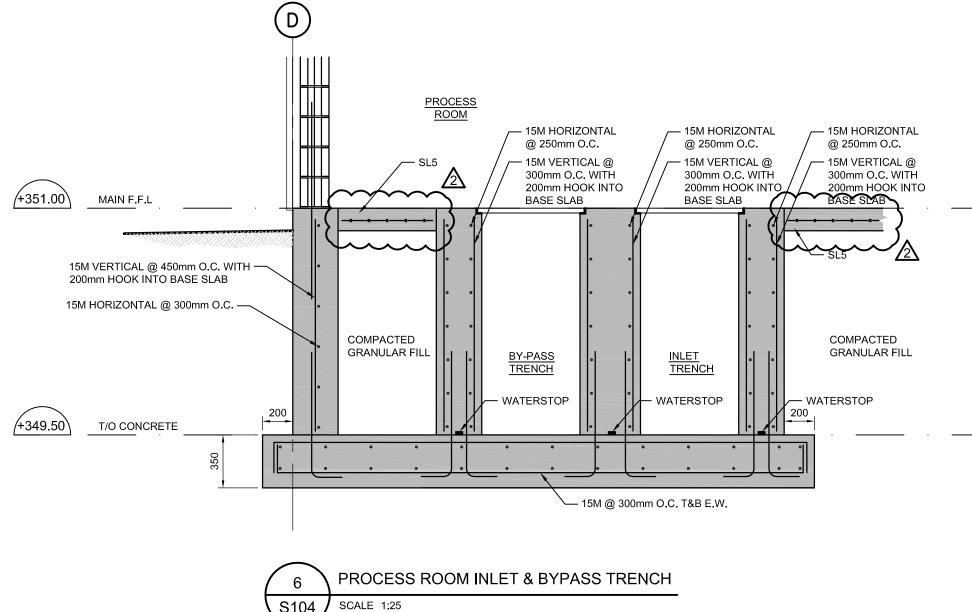

S104 SCALE 1:25


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	of offissions to this office prior to construction.
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	1	ISSUED FOR 90% REVIEW	OCT. 2015	
es	2	ISSUED FOR TENDER	DEC. 2015	
	3	REVISED AS PER ADDENDUM NO. 2	JAN. 2016	



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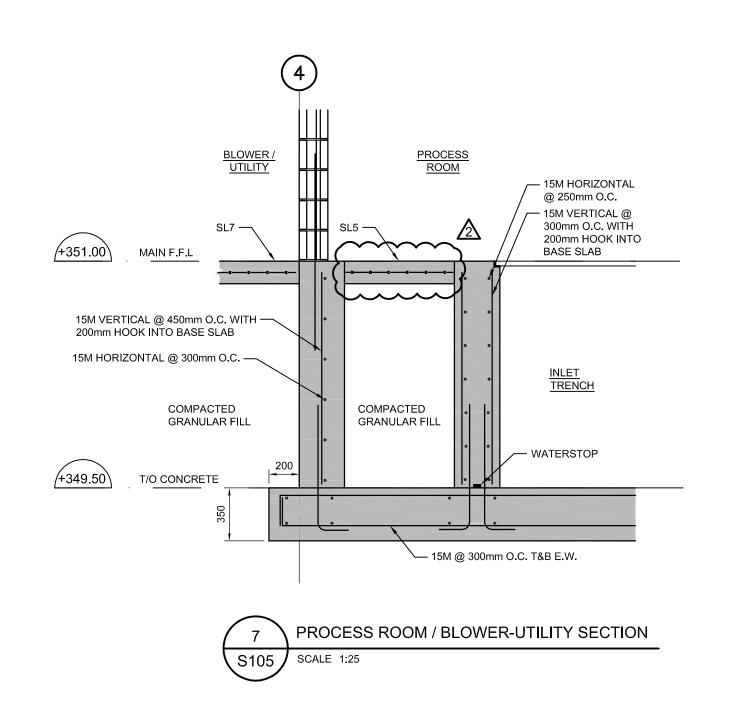
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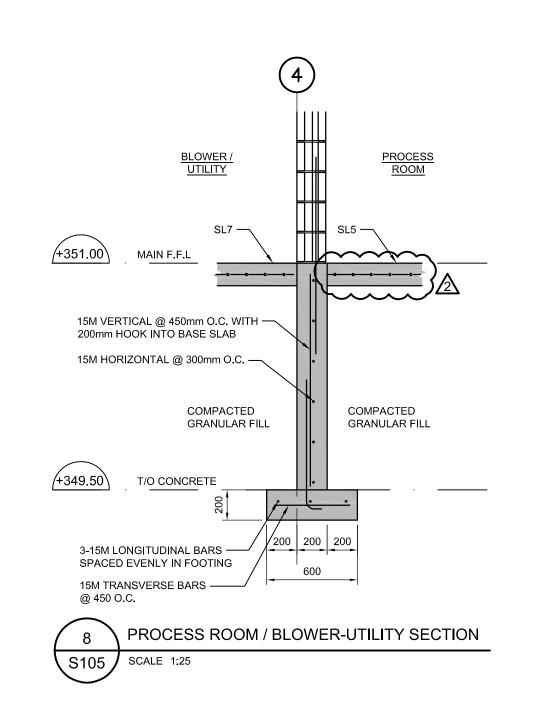
web www rjburnside.com


ALMA ST. WASTEWATER PRETREATMENT FACILITY UPGRADES STRUCTURAL FOUNDATION DETAILS


TOWNSHIP OF GUELPH / ERAMOSA 8348 WELLINGTON ROAD 124, P.O. BOX 700 ROCKWOOD, ON

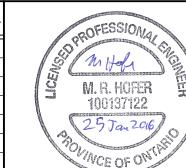
Drawing No. M.H. M.H. M.H. 15/02/28 **S104** MSA143810.0062 MSA143810.0062 Scale AS NOTED





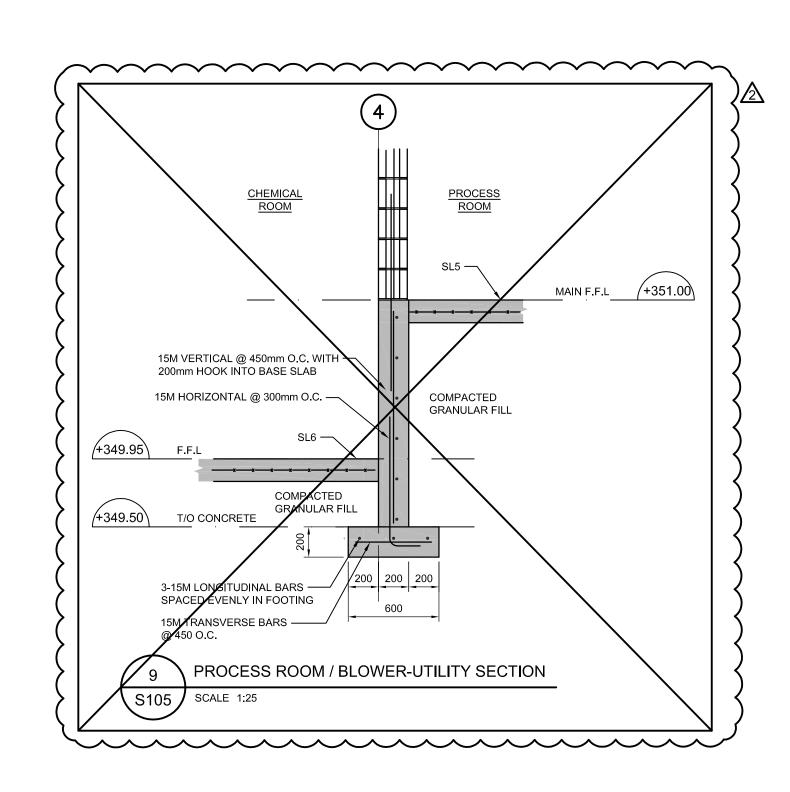

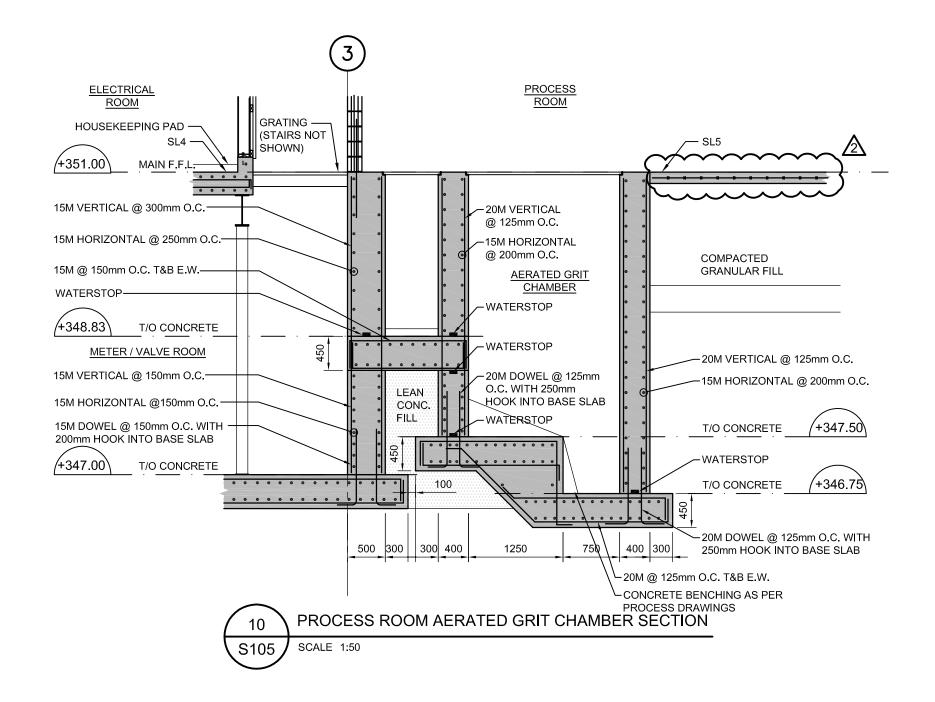

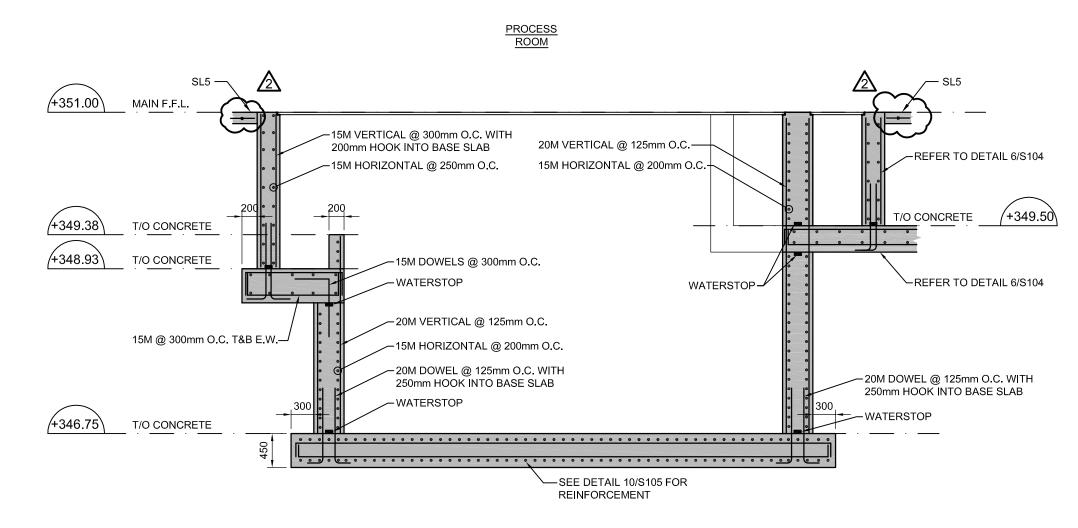

PROCESS ROOM AERATED GRIT CHAMBER SECTION S105 | SCALE 1:50

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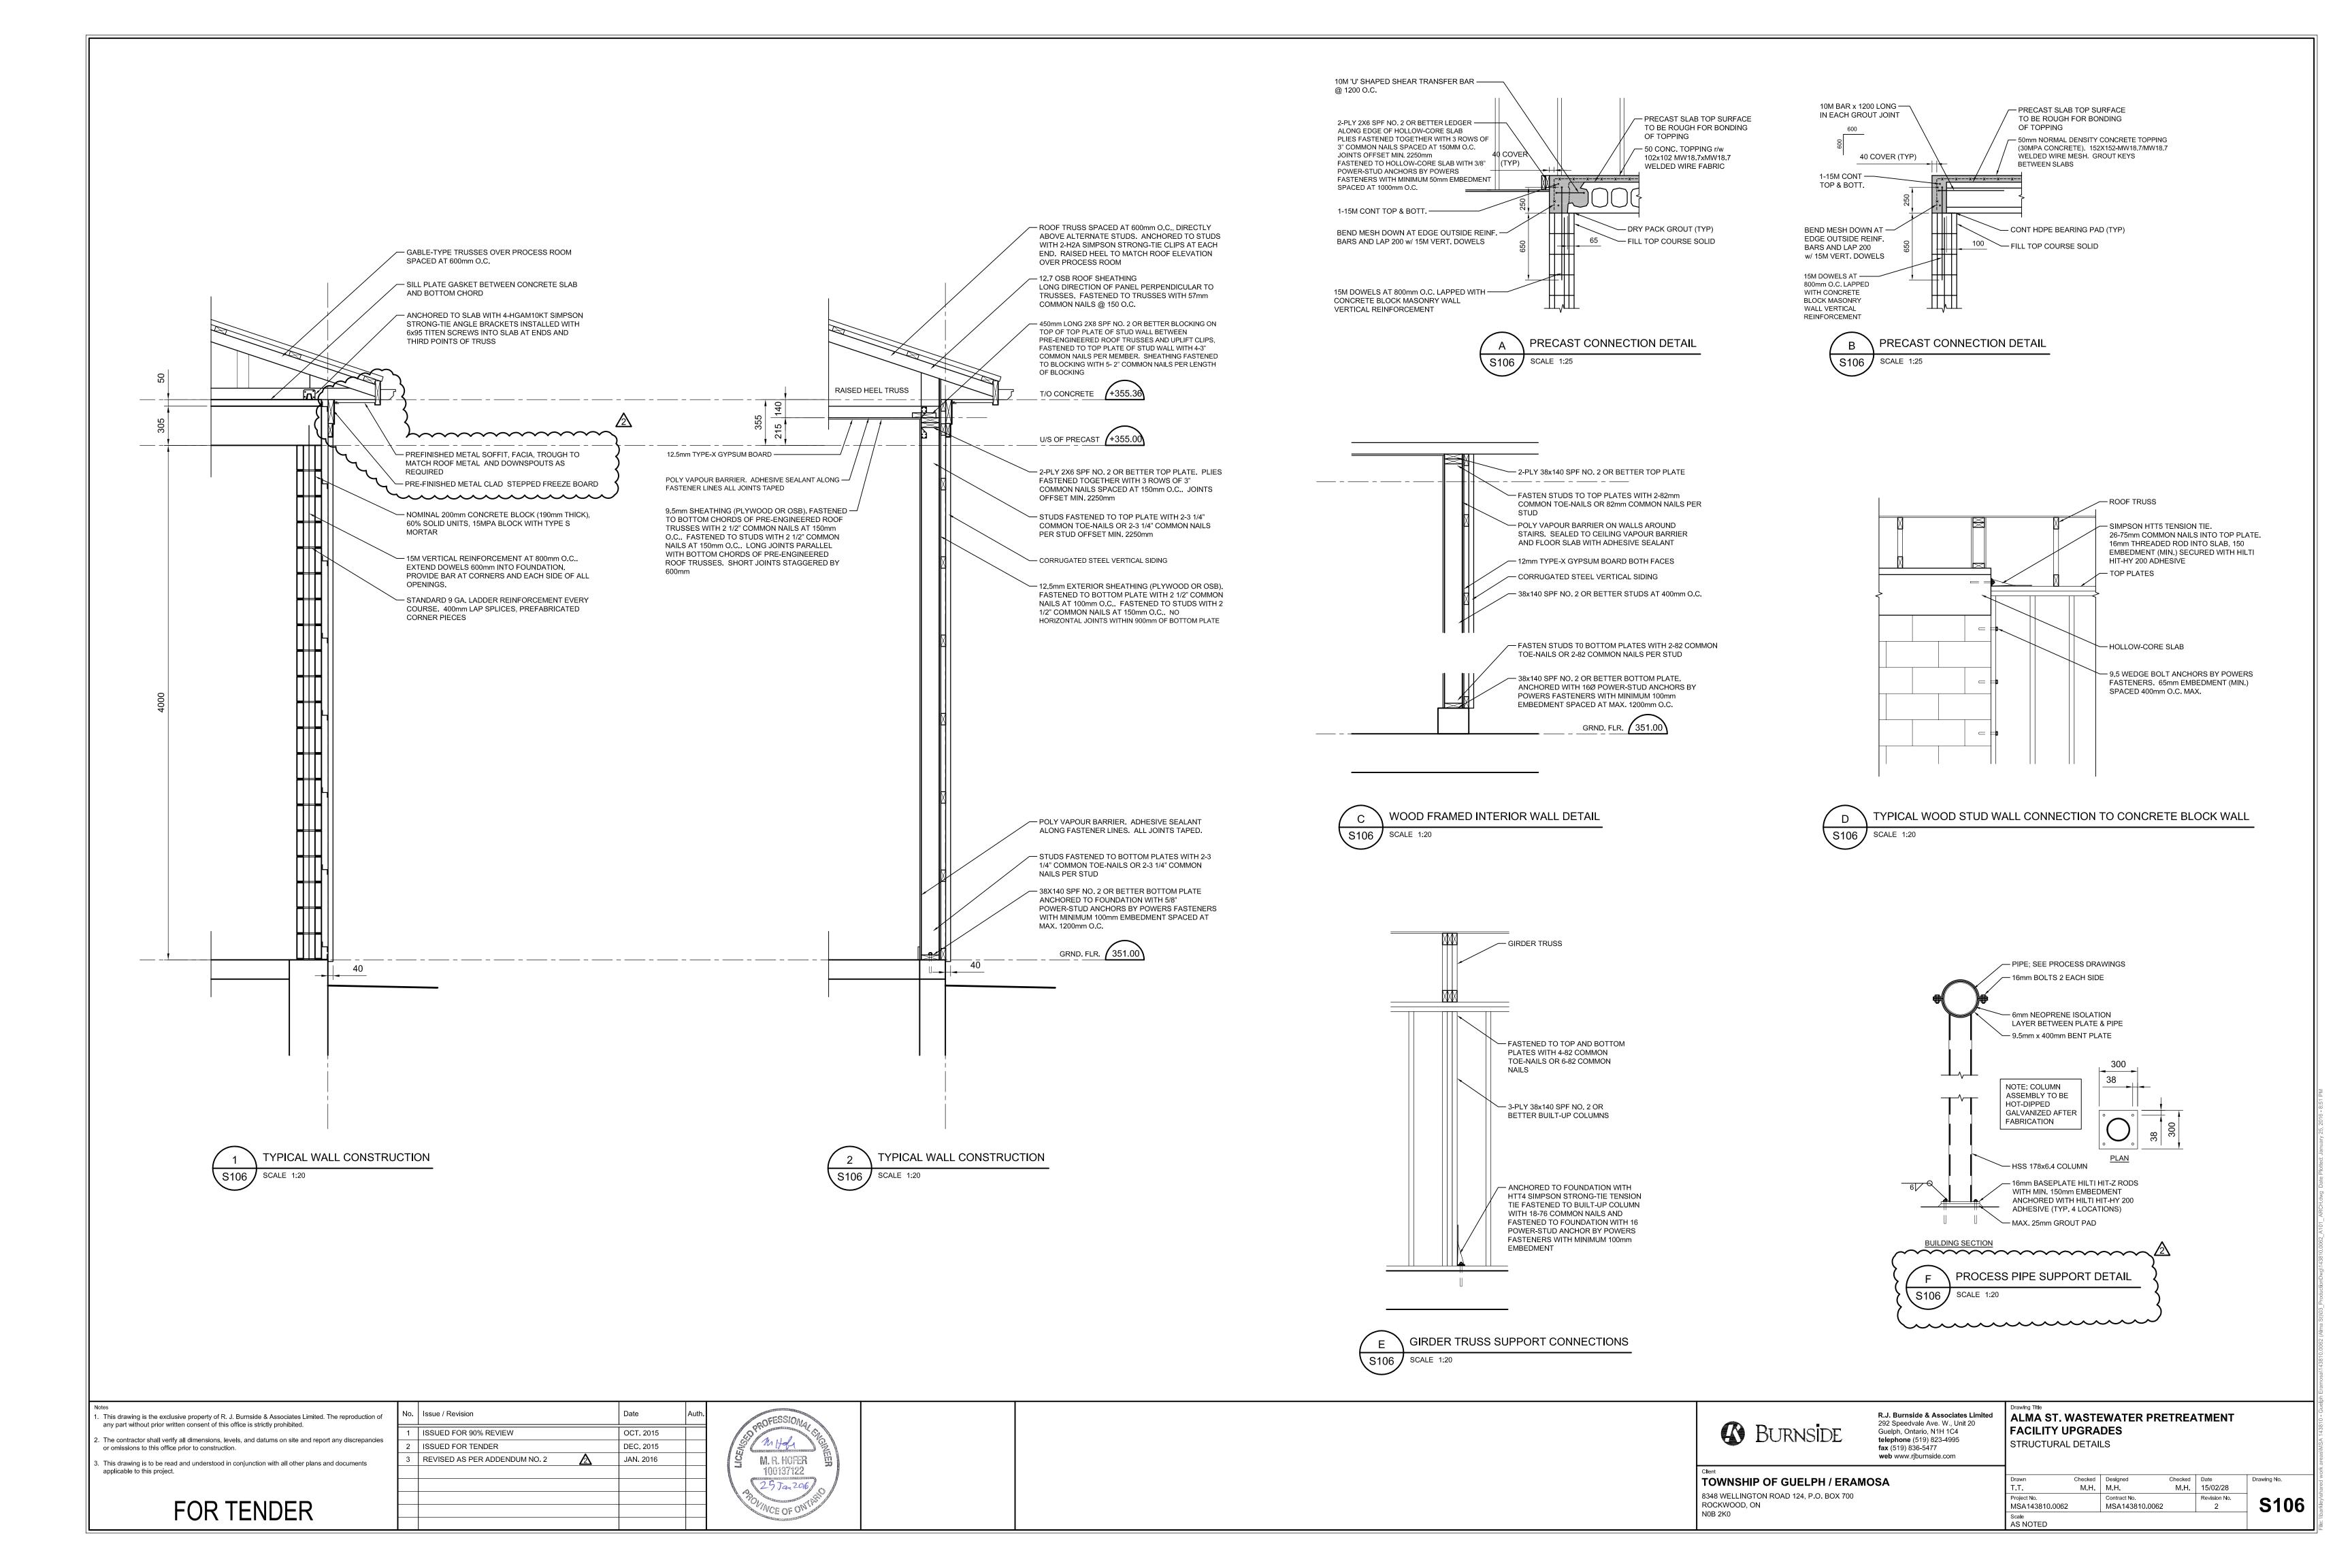
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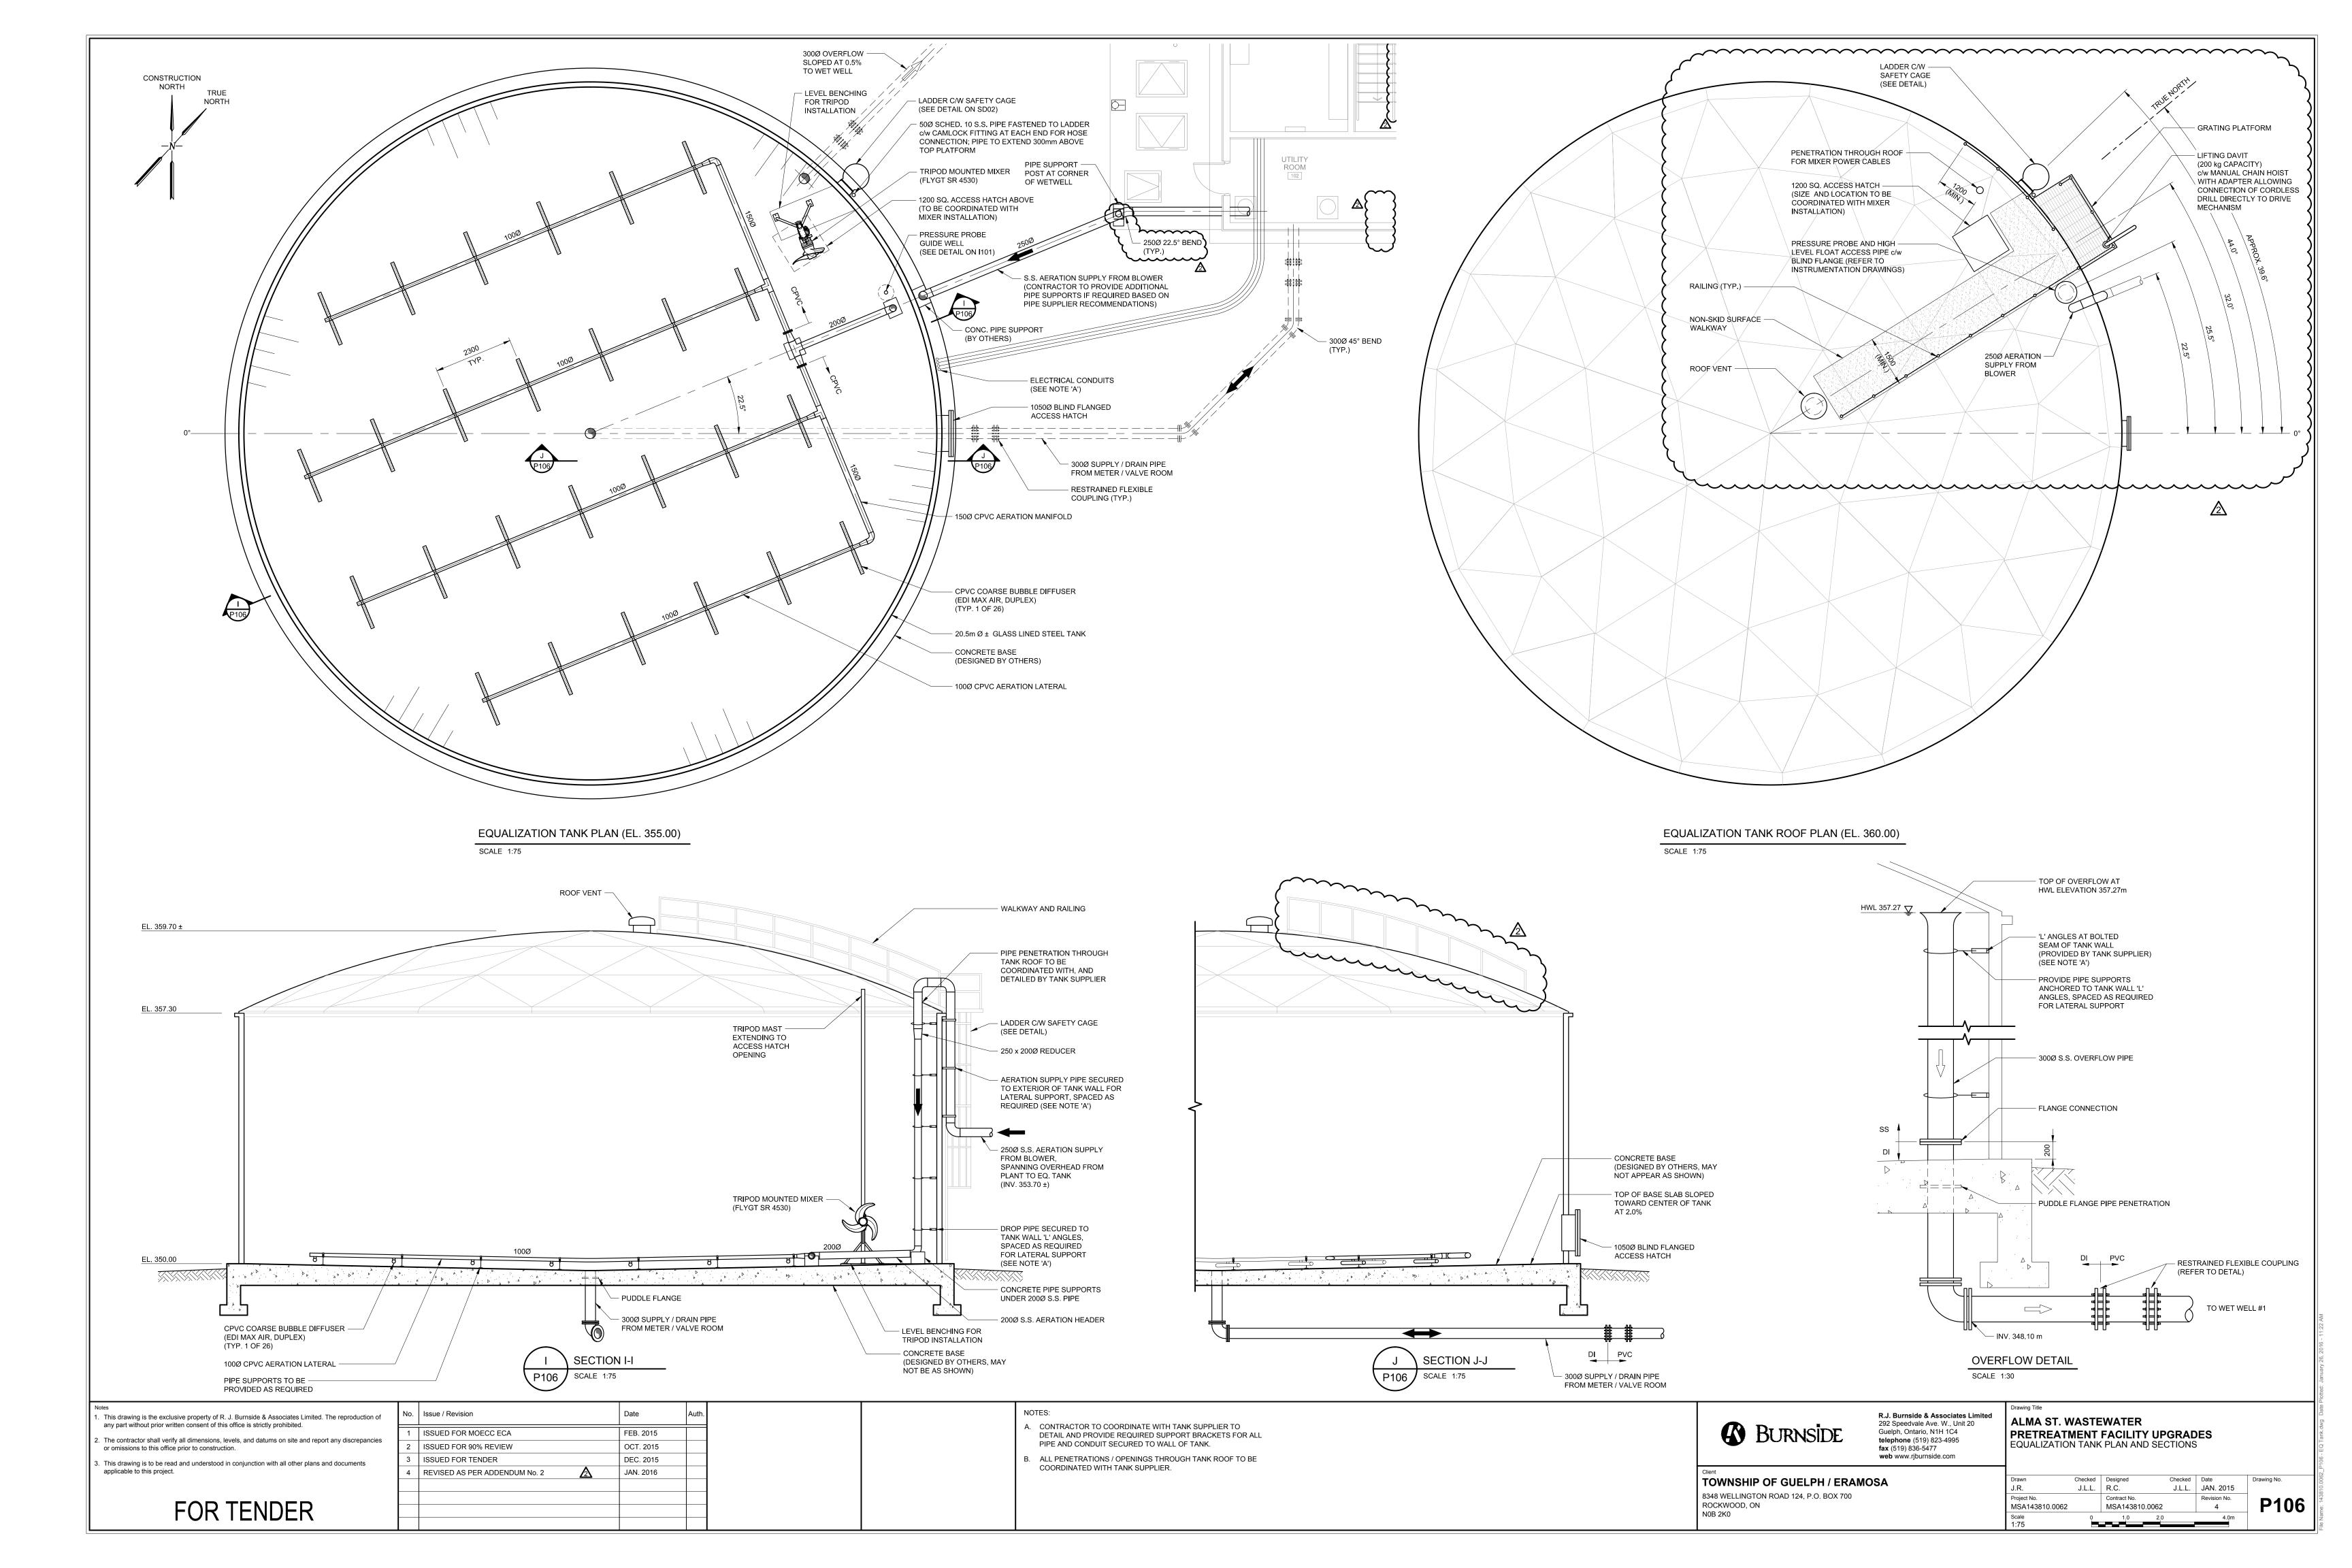
R.J. Burnside & Associates Limited 292 Speedvale Ave. W., Unit 20 Guelph, Ontario, N1H 1C4 telephone (519) 823-4995 fax (519) 836-5477 web www.rjburnside.com


ALMA ST. WASTEWATER PRETREATMENT FACILITY UPGRADES STRUCTURAL FOUNDATION DETAILS

TOWNSHIP OF GUELPH / ERAMOSA 8348 WELLINGTON ROAD 124, P.O. BOX 700 ROCKWOOD, ON N0B 2K0

Checked Date
M.H. 15/02/28 Drawing No. M.H. M.H. **S105** MSA143810.0062 MSA143810.0062 Scale AS NOTED





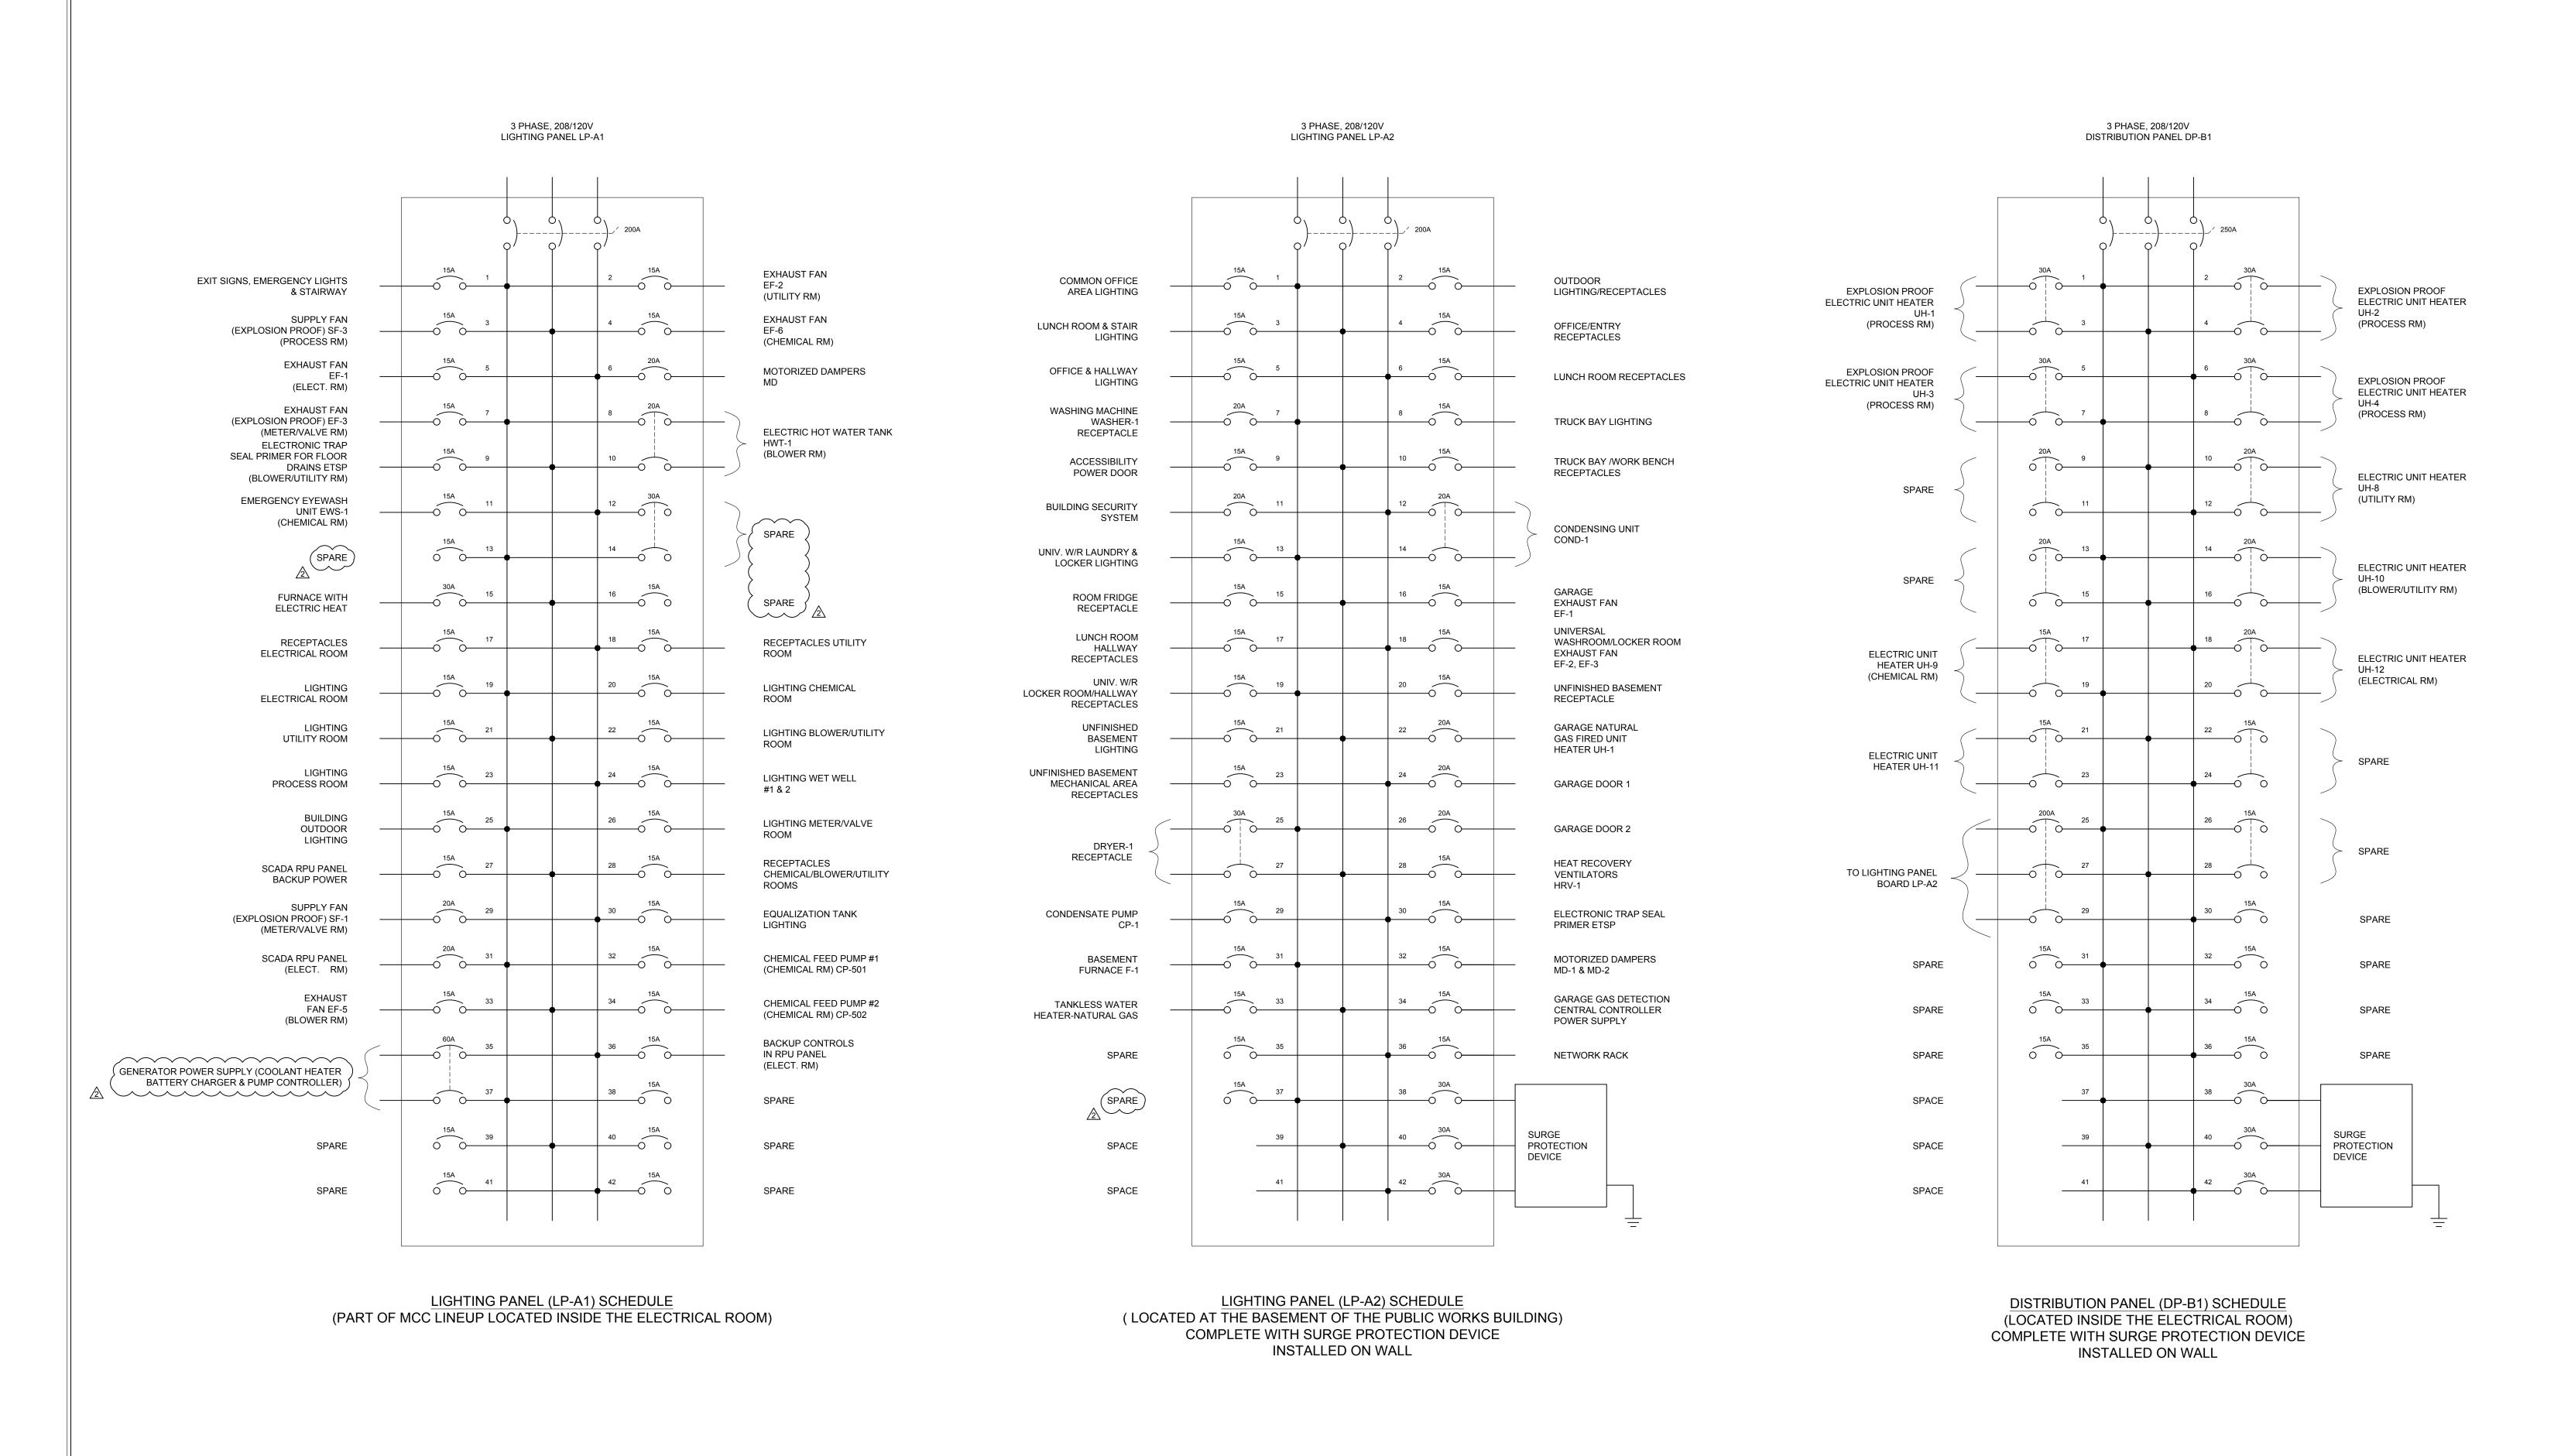

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 Date
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 FEB. 2015
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 ISSUED FOR 90% REVIEW
 OCT. 2015
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 ISSUED FOR TENDER
 DEC. 2015
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 REVISED AS PER ADDENDUM No. 2
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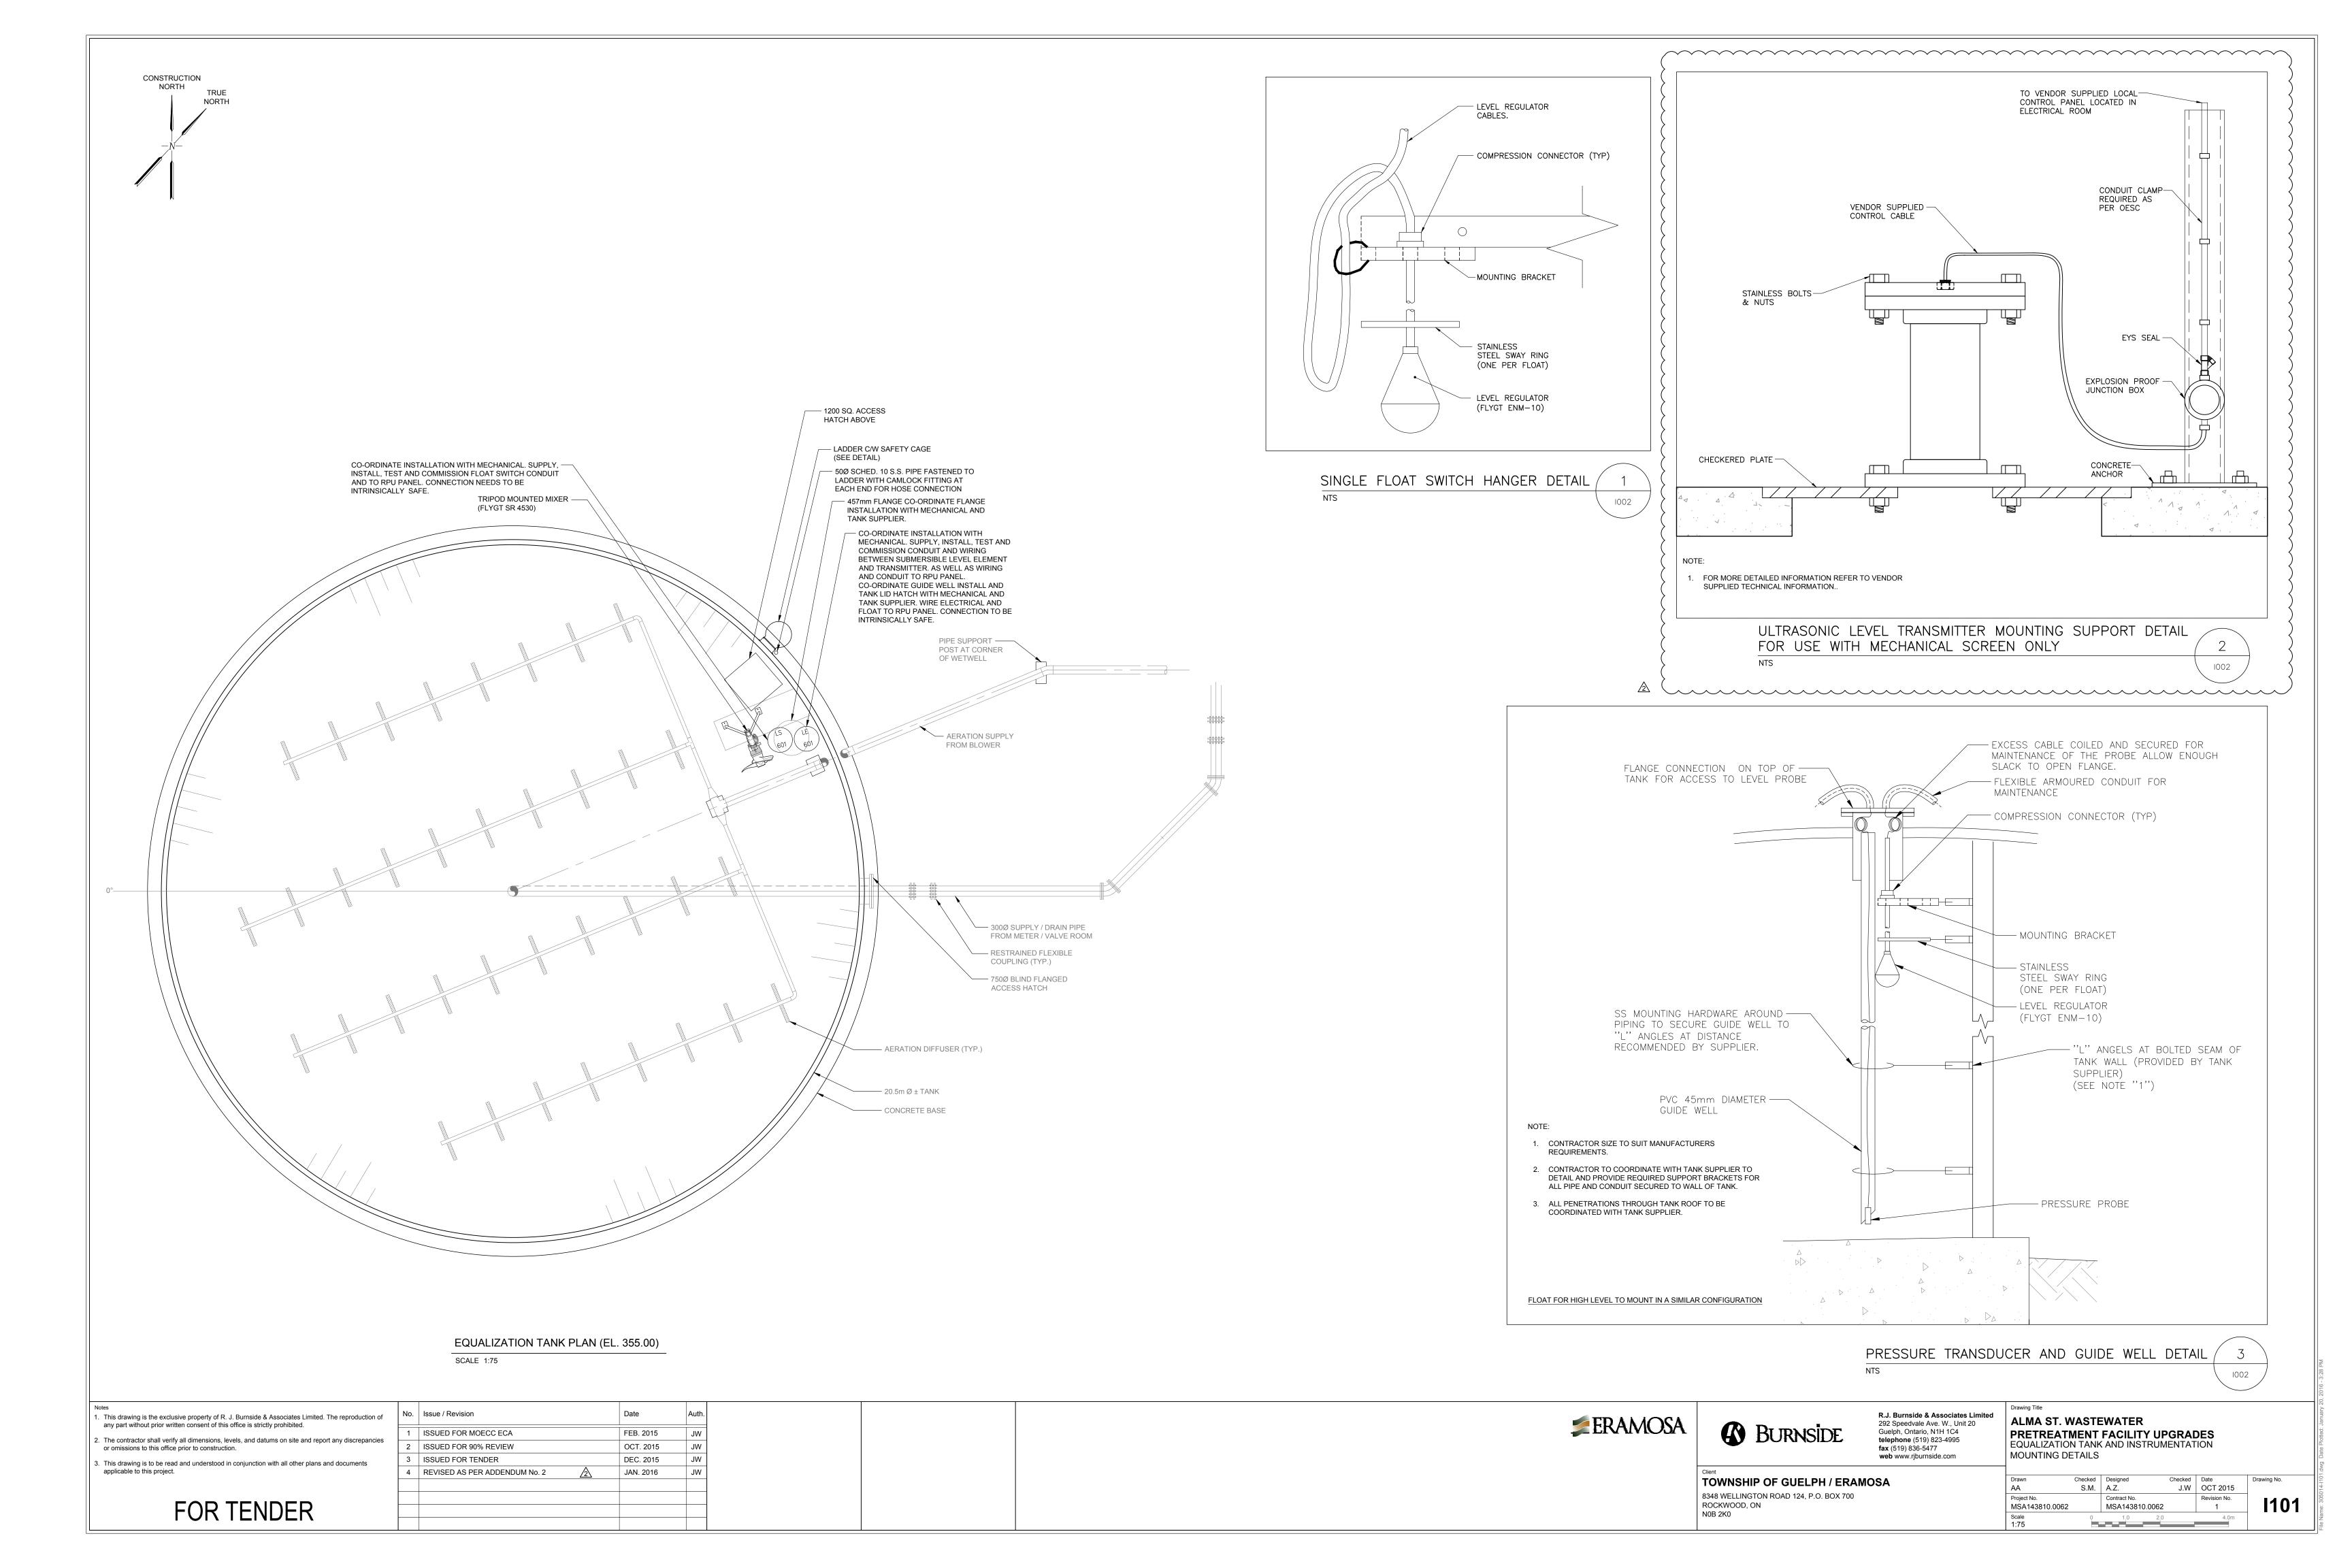
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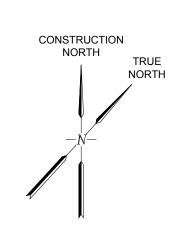
R.J. Burnside & Associates Limited 292 Speedvale Ave. W., Unit 20 Guelph, Ontario, N1H 1C4 telephone (519) 823-4995 fax (519) 836-5477


PRETREATMENT FACILITY UPGRADES
LIGHTING & DISTRIBUTION
PANELS LAYOUT SCHEDULES

TOWNSHIP OF GUELPH / ERAMOSA

8348 WELLINGTON ROAD 124, P.O. BOX 700
ROCKWOOD, ON
N0B 2K0





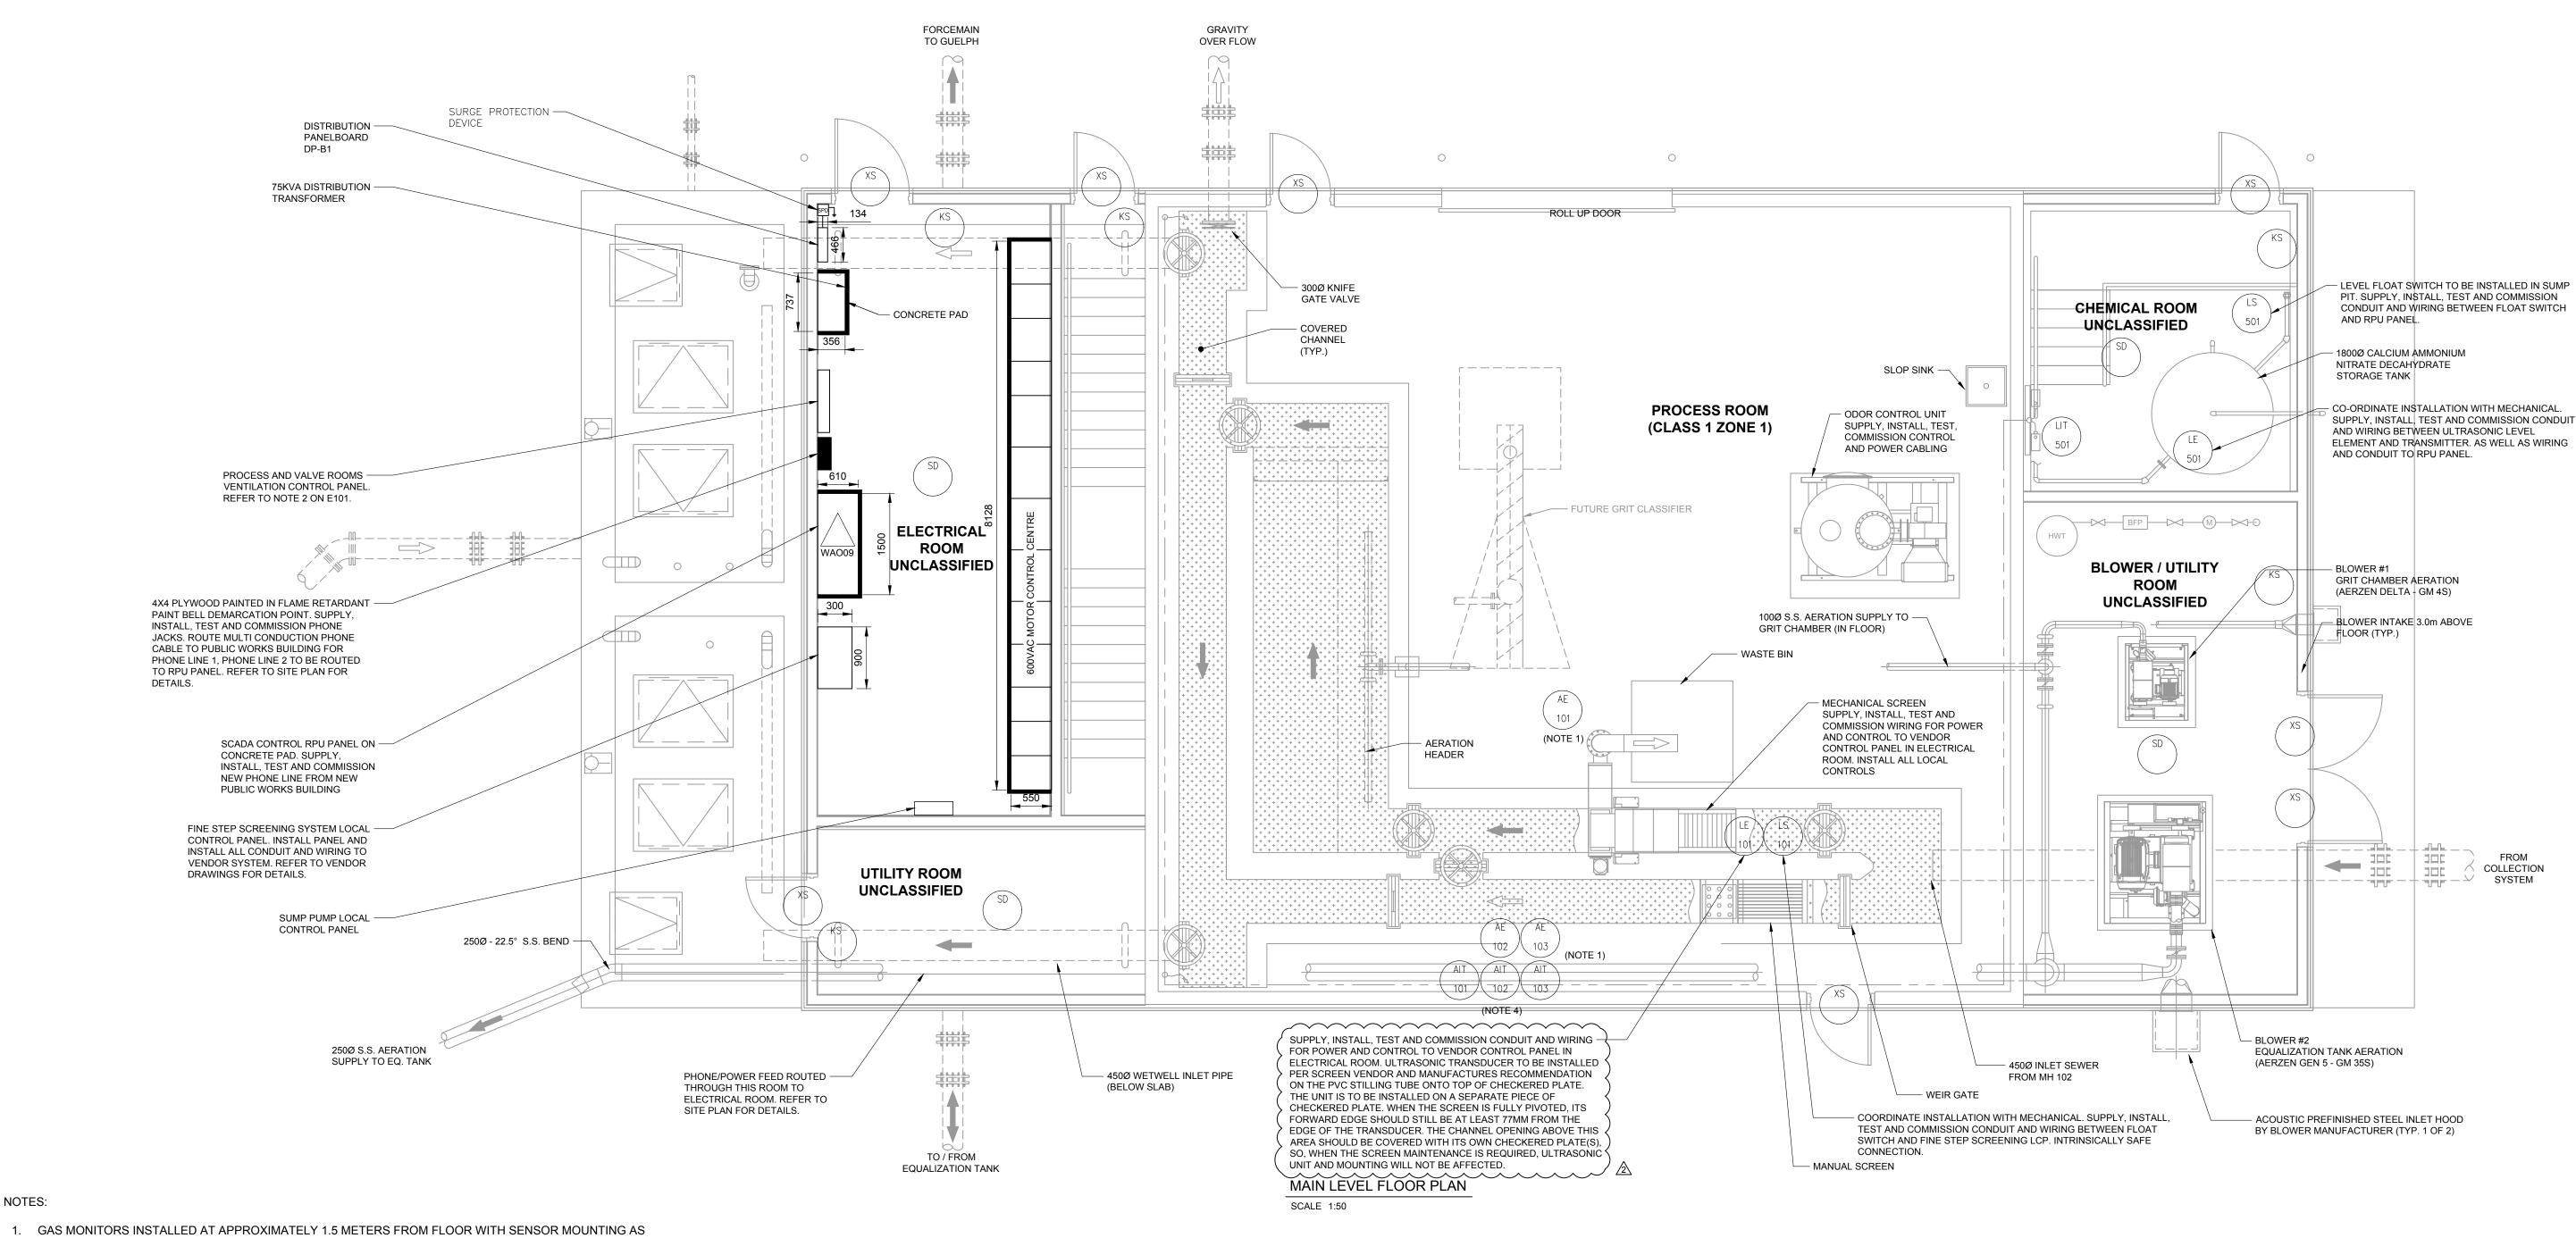

NOTES:

- FOLLOWS (REFER TO MANUFACTURES REQUIREMENTS). LEL AT 18" BELOW CEILING (AIT/AE101)
- H2S AT 450mm FROM FLOOR (AIT/AE102) O2 AT DISPLAY (AIT/AE103)
- 2. GAS SENSOR CALIBRATION TUBING REQUIRED FOR LEL AND H2S SUPPLY AND INSTALL.
- 3. EYS SEALS AND INTRINSIC BARRIERS REQUIRED FOR EQUIPMENT INSTALLED IN CLASSIFIED AREAS.
- 4. CO-ORDINATE INSTALLATION WITH MECHANICAL. SUPPLY, INSTALL, TEST AND COMMISSION CONDUIT AND
- WIRING BETWEEN GAS MONITORS AND VENTILATION CONTROL PANEL. 5. REFER TO VENDOR DETAILS ON ELECTRICAL AND CONTROL REQUIREMENTS OF THE CONTRACTOR FOR
- WIRING, INSTALLATION AND COMMISSIONS OF A COMPLETE SCREEN SYSTEM.
- I. This drawing is the exclusive property of R. J. Burnside & Associates Limited. The reproduc any part without prior written consent of this office is strictly prohibited. 2. The contractor shall verify all dimensions, levels, and datums on site and report any discrep

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ananaiaa	1	ISSUED FOR MOECC ECA		FEB. 2015	JW
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nts	3	ISSUED FOR TENDER		DEC. 2015	JW
	4	REVISED AS PER ADDENDUM No. 2	<u> </u>	JAN. 2016	JW

ERAMOSA

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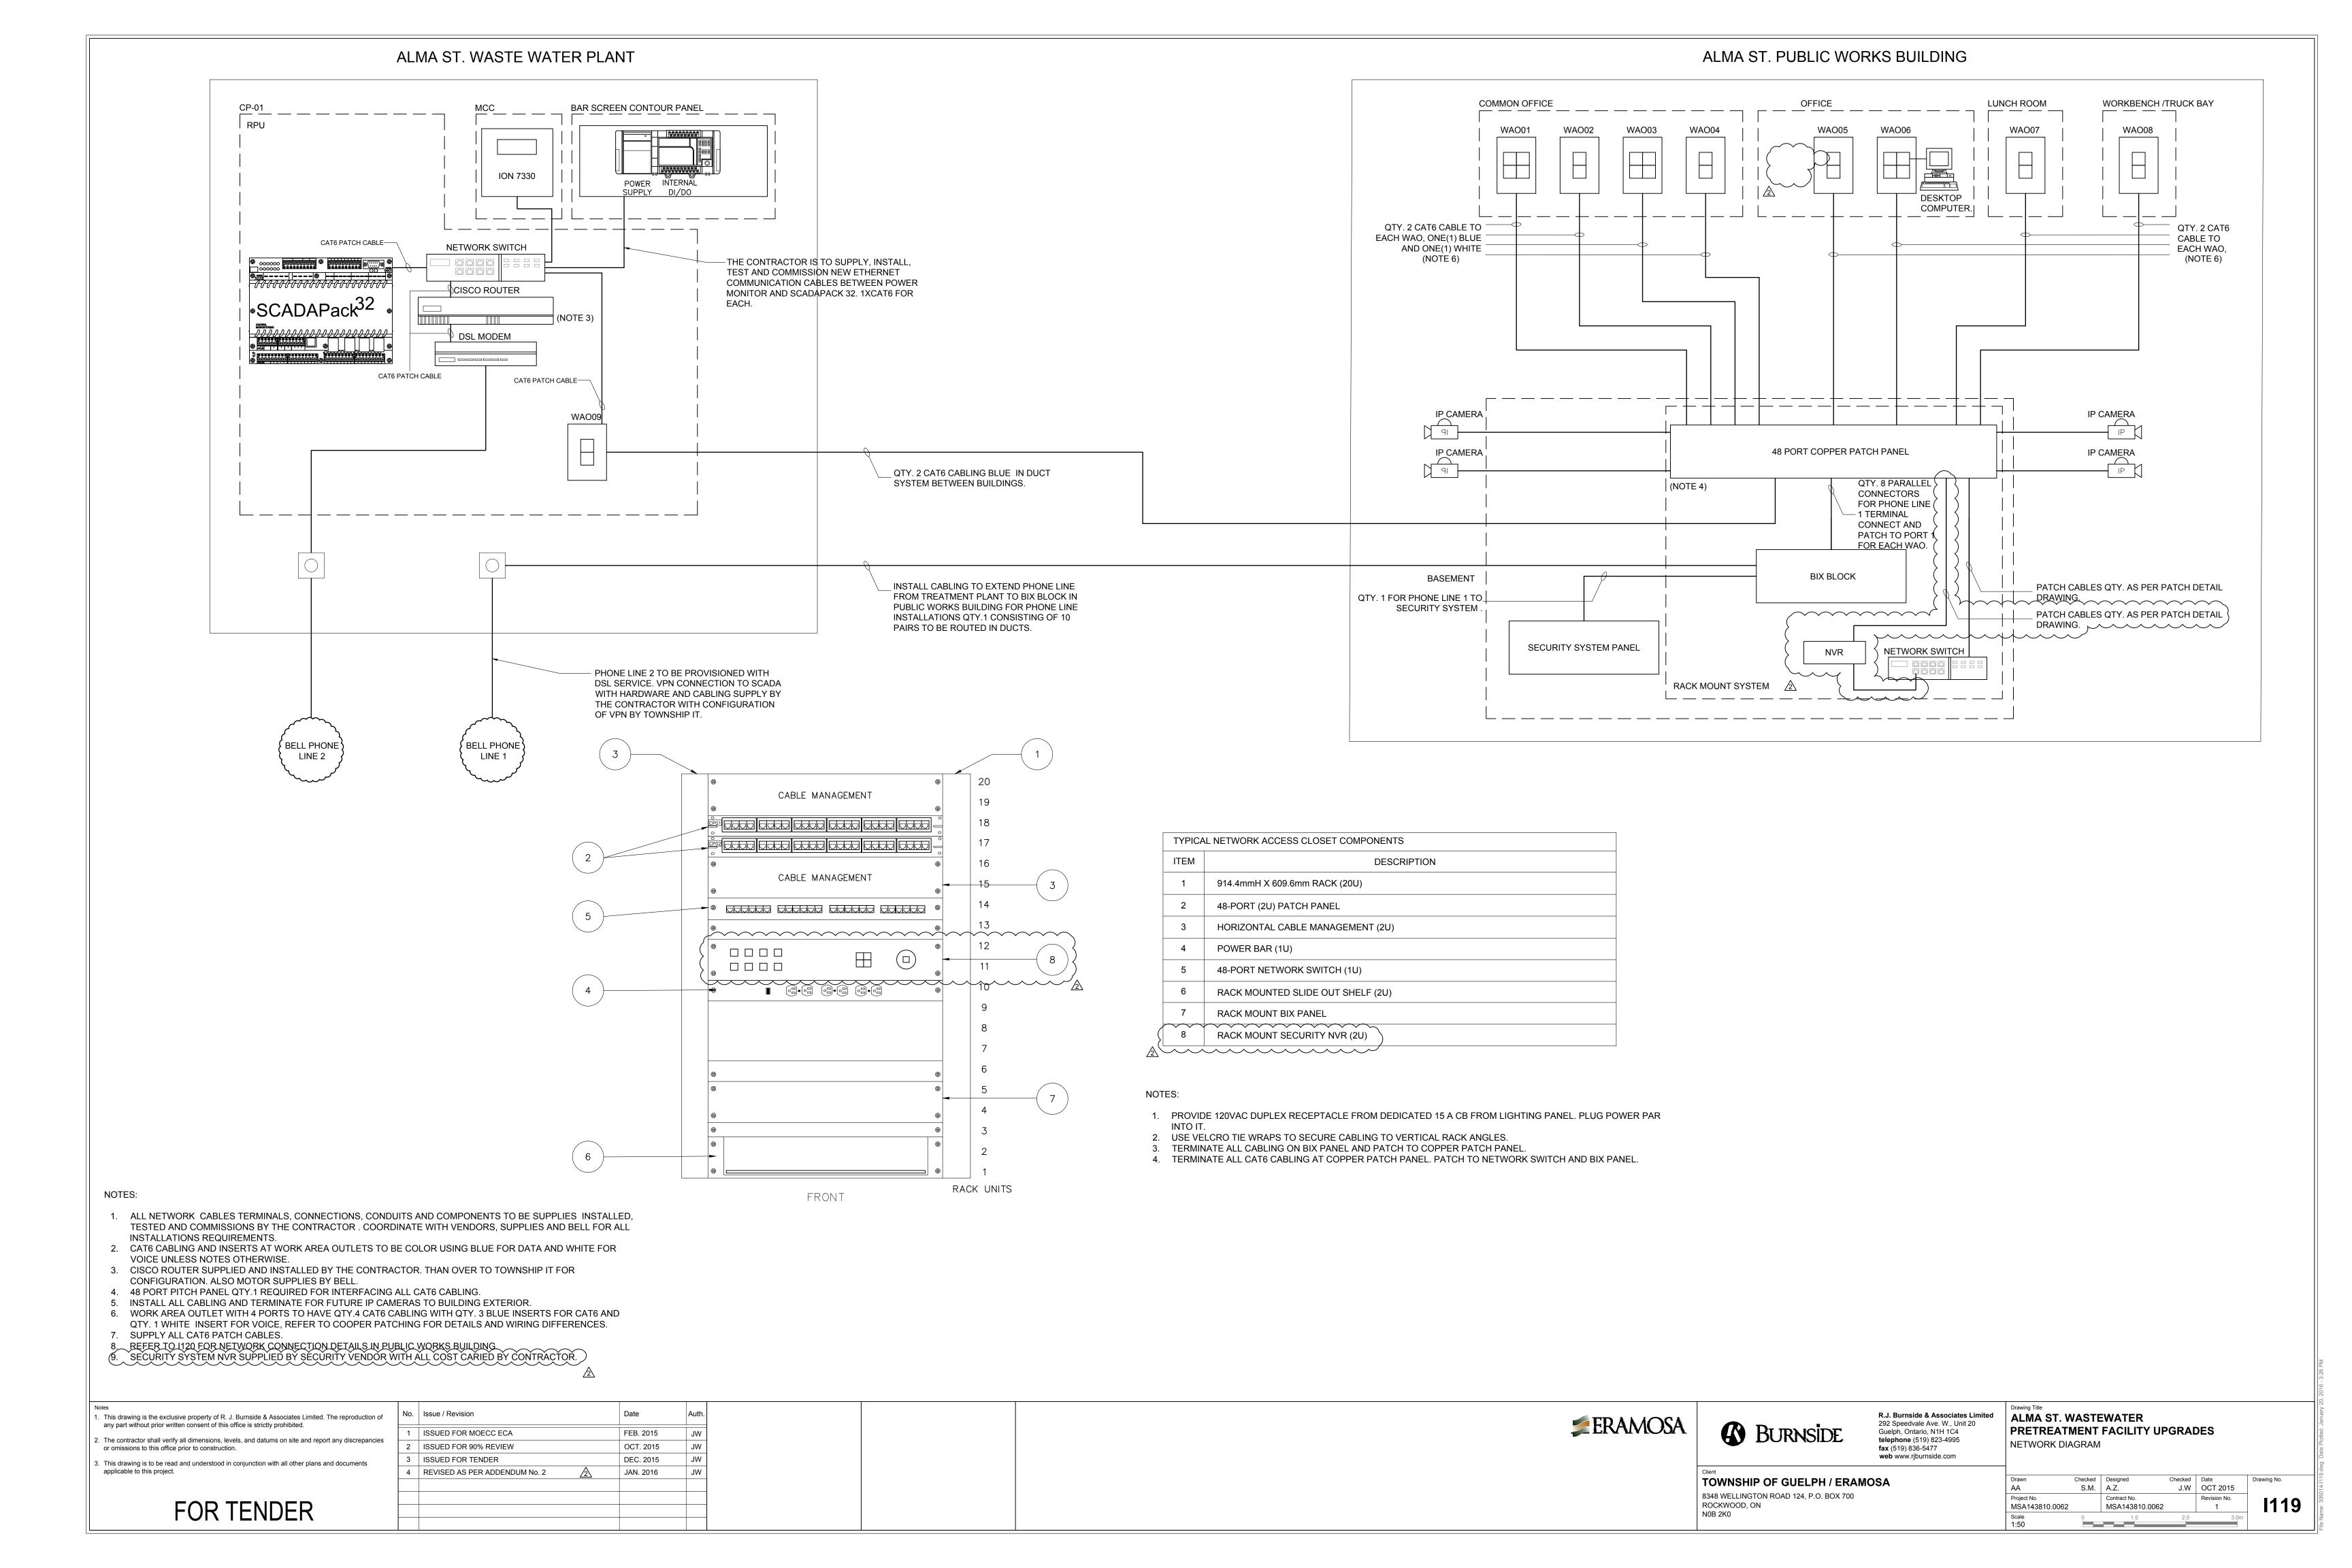
R.J. Burnside & Associates Limited 292 Speedvale Ave. W., Unit 20 Guelph, Ontario, N1H 1C4 telephone (519) 823-4995 fax (519) 836-5477


ALMA ST. WASTEWATER PRETREATMENT FACILITY UPGRADES PROCESS MAIN LEVEL FLOOR PLAN

TOWNSHIP OF GUELPH / ERAMOSA 8348 WELLINGTON ROAD 124, P.O. BOX 700 ROCKWOOD, ON N0B 2K0

Checked Date
J.W OCT 2015 S.M. A.Z. MSA143810.0062 MSA143810.0062

I103



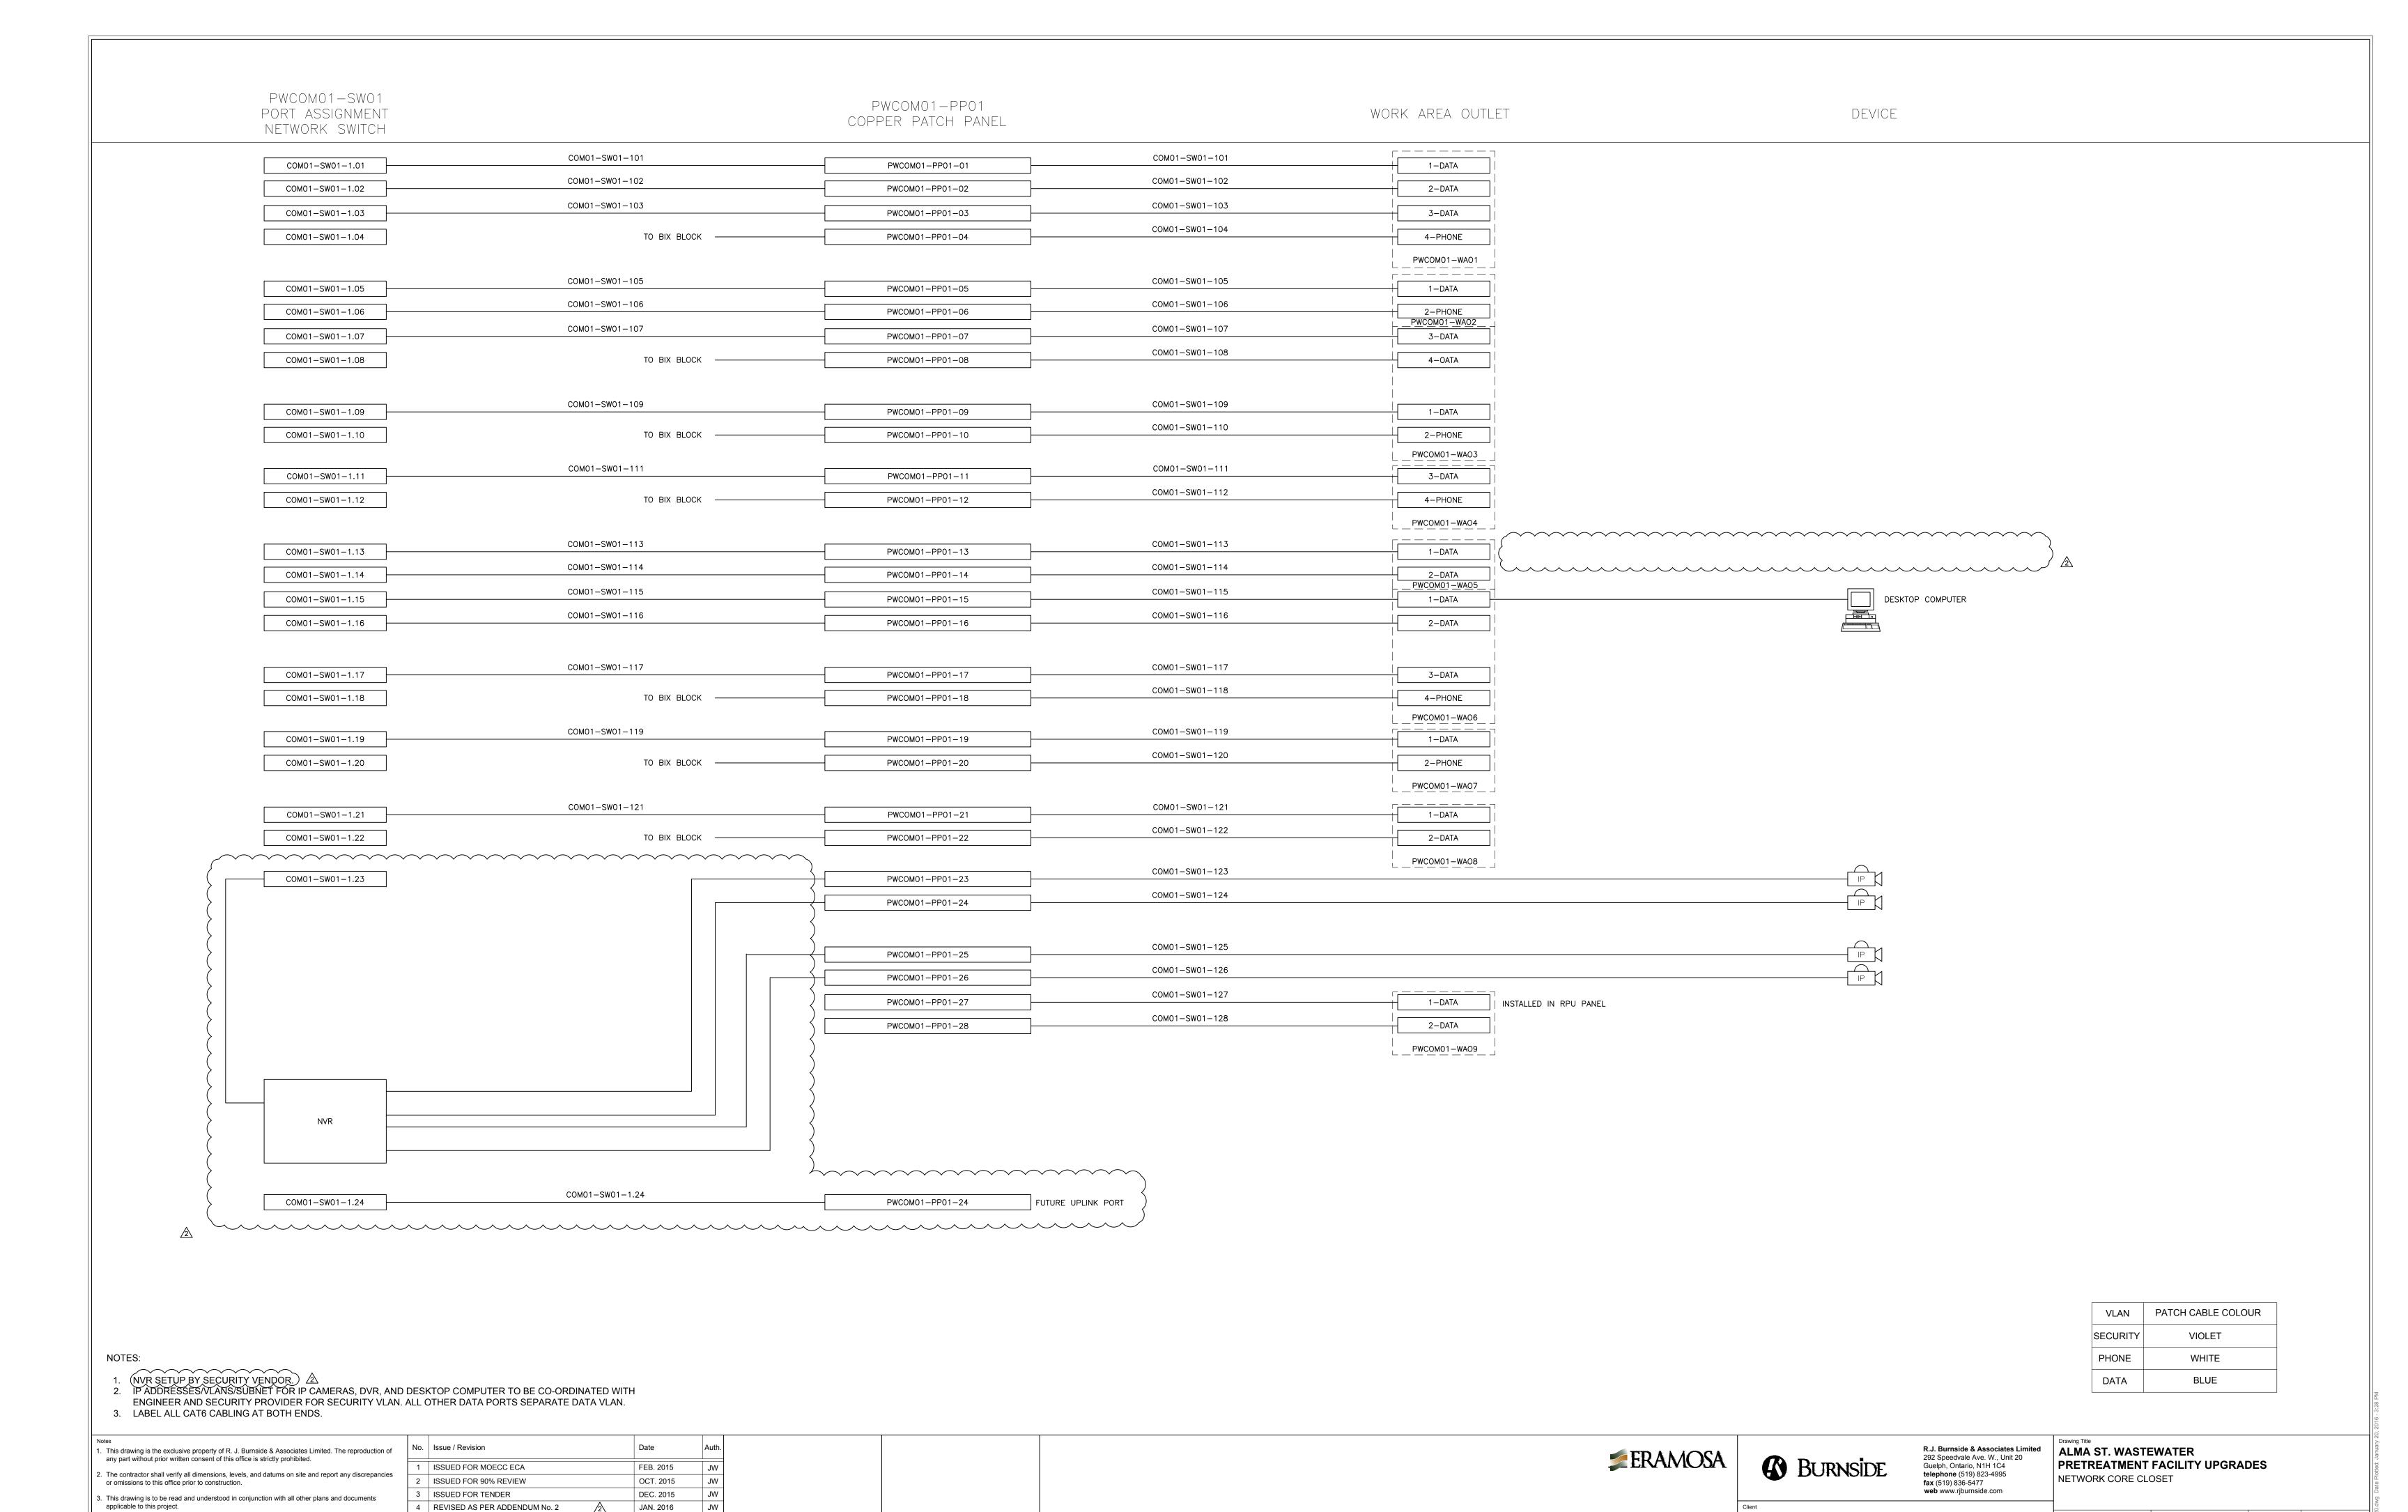

Checked Date
J.W OCT 2015

Revision No.

I120

S.M. A.Z.

MSA143810.0062


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TOWNSHIP OF GUELPH / ERAMOSA

8348 WELLINGTON ROAD 124, P.O. BOX 700

ROCKWOOD, ON

N0B 2K0

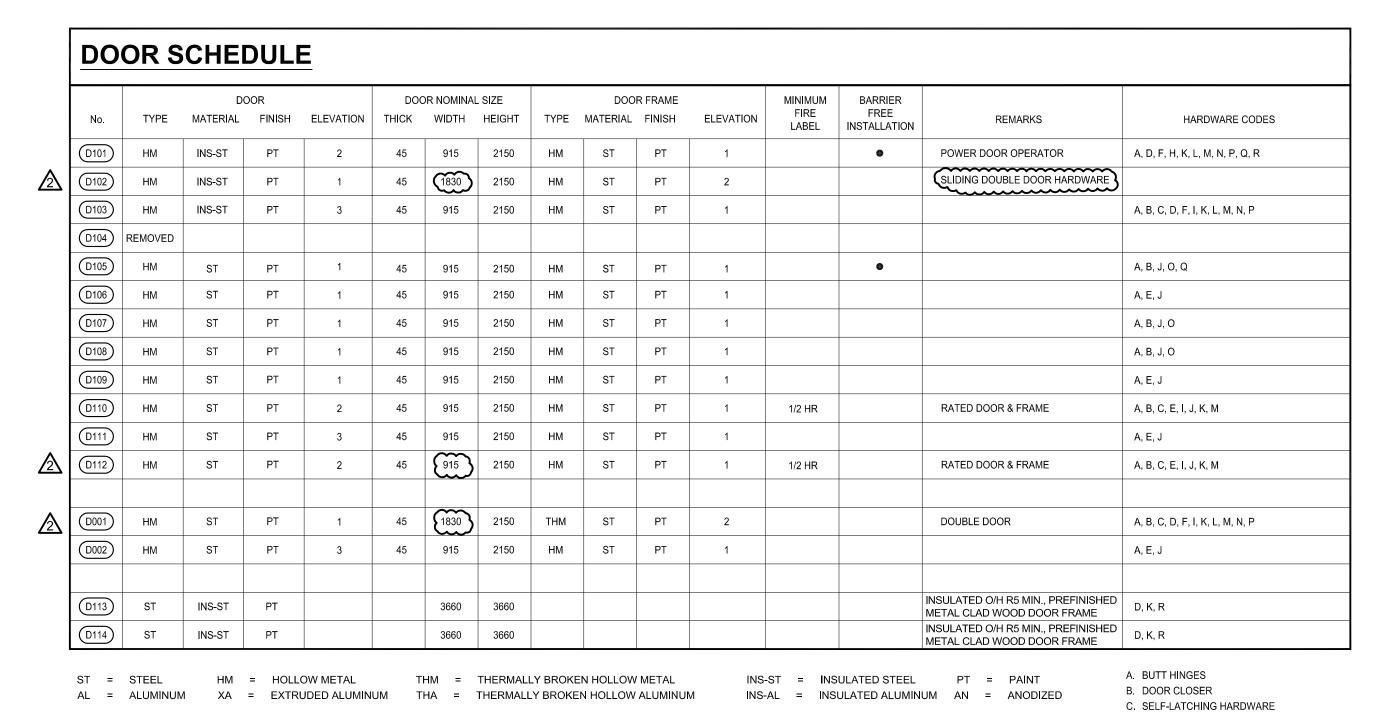

(TYP.) 2 3 (2)

DOOR ELEVATIONS TEMPERED GLAZING TYPICAL, WIRED GLAZING AS REQUIRED FOR RATED CLOSURES

NOTES:

AS PER O.B.C. REQUIREMENTS.

TYPICAL HANDRAIL / GUARD

PER O.B.C.

METAL TUBE GUARD AS -

FRAME ELEVATIONS

1. UNDER CUT WASHROOM DOORS TO MEET VENTILATION REQUIREMENTS. 2. ALL GLAZING TO BE TEMPERED. USE GEORGIAN WIRE GLAZING IN ALL RATED LITES/DOORS. 3. INSULATE ALL EXTERIOR DOORS AND FRAMES.

4. ALL STEEL FRAMES TO BE WELDED. 5. ALL DOORS LOCATED IN A FIRE SEPARATION ARE TO BE EQUIPPED WITH A POSITIVE LATCHING MECHANISM DESIGNED TO HOLD THE DOOR CLOSED AFTER EACH USE IN ACCORDANCE TO ONTARIO BUILDING CODE ARTICLE

6. AFFIX BARRIER-FREE SIGNAGE TO DOORS AS PER O.B.C. 7. GLAZING IN EXTERIOR DOORS TO BE DOUBLE GLAZED 8. DOUBLE DOOR TO INCLUDE LOCKING THUMB LATCH ON EXTERIOR OF LEFT LEAF, SELF CLOSER ON LEFT LEAF WITH HOLD OPEN. SWING LIMITING HOLD OPEN ON RIGHT LEAF, DEAD BOLTS AT TOP AND BOTTOM ON RIGHT LEAF W/ ASTRAGAL

CONSTRUCTION LEGEND

ROOF CONSTRUCTION

PRE FINISHED METAL ROOF CLADDING ICE AND WATER SHIELD 1800 FROM ALL EDGES ASPHALT BUILDING PAPER OVER REMAINING ROOF 12.7 OSB SHEATHING PRE ENGINEERED WOOD ROOF TRUSSES @ 600 CC ROCK WOOL BATT INSULATION RSI 8.81 (R50) 6MIL POLY AIR/VAPOUR BARRIER 15.8 CEILING GYPSUM BOARD

FLOOR CONSTRUCTION

- MAIN FLOOR 45MIN. F.R.R. (O.B.C. SB-3 F6h) OR MEMBRANE CEILING (O.B.C. SB-2 2.3.12) LOOR FINISH AS PER SCHEDULE 15.5 PLYWOOD SUBFLOOR (GLUE/SCREW) ENGINEERED FLOOR JOIST AS PER PLANS 100 ROXUL SAFE & SOUND INSULATION 2 LAYERS OF 12 TYPE 'X' GYPSUM BOARD
- CONCRETE SLAB (SEE STRUCTURAL) (TROWEL /MACHINE TO SUITABLE ACCEPTABLE 50 RIGID INSULATION 150 COMPACTED GRANULAR 'A' COMPACTED TO

FILL AS REQUIRED (SEE STRUCTURAL)

BASEMENT FLOOR SLAB
CONCRETE SLAB (SEE STRUCTURAL) (TROWEL /MACHINE TO SUITABLE ACCEPTABLE 150 COMPACTED GRANULAR 'A' COMPACTED TO 100% SPD FILL AS REQUIRED (SEE STRUCTURAL)

WALL CONSTRUCTION

- FOUNDATION WALL PARGING ABOVE GRADE DAMPPROOF EXTERIOR PERIMETER OF FOUNDATION POURED CONCRETE WALL RIGID INSULATION WHERE REQUIRED
- PARGING ABOVE GRADE DIMPLED HIGH DENSITY POLYETHYLENE DRAINAGE MEMBRANE BELOW GRADE DAMPPROOF EXTERIOR PERIMETER OF FOUNDATION POURED CONCRETE WALL (REINFORCING AS SHOWN IN DETAILS)

AIR BARRIER TO GRADE RSI 1.06 (R6) MINERAL WOOL BOARD INSULATION 38X89 SPF NO. 1/2 STUDS @ 609 O/C (SILL GASKET BELOW) RSI 2.47 (R14) MINERAL WOOL INSULATION BETWEEN STUDS 6 MIL VAPOUR BARRIER 12.7 TYPE 'X' GYPSUM WALL BOARD FINISHED

SEE ROOM FINISH SCHEDULE FOR DETAILS

90 FACE BRICK 25.4 AIR SPACE AIR BARRIER 12 EXTERIOR SPF SHEATHING 38X140 SPF NO 1/2 STUDS @ 406 O/C RSI 3.87 (R22) ROXUL BATT

2.7 GYPSUM WALL BOARD FINISHED

SEE ROOM FINISH SCHEDULE FOR DETAILS

6 MIL. VAPOUR BARRIER

EXTERIOR BRICK WALL 45 MIN. F.R.R. CONSTRUCTION AS PER W3; SUBSTITUTE: INTERIOR GYPSUM BOARD WITH 12.7 TYPE 'X' GYPSUM WALL BOARD FINISHED SEE ROOM FINISH SCHEDULE FOR DETAILS

- CONSTRUCTION AS PER W3; SUBSTITUTE INTERIOR GYPSUM BOARD WITH 6 DOUGLAS FIR PLYWOOD (GARAGE SIDE)
- EXTERIOR BRICK GARAGE 45 MIN. F.R.R. (OBC SB-3 EW1B) CONSTRUCTION AS PER W3a; ADD: 6 DOUGLAS FIR PLYWOOD GARAGE SIDE
- METAL SIDING AS PER CLIENT 19X89 HORIZONTAL STRAPPING @ 609 0.C. AIR BARRIER 12 EXTERIOR SPF SHEATHING 38X140 SPF NO 1/2 STUDS @ 406 O/C RSI 3.87 (R22)ROXUL BATT 6 MIL. VAPOÚR BARRIER 12.7 GYPSUM WALL BOARD FINISHED SEE ROOM FINISH SCHEDULE FOR DETAILS
- EXTERIOR VINYL 45 MIN. F.R.R. CONSTRUCTION AS PER W4; SUBSTITUTE: INTERIOR GYPSUM BOARD WITH 12.7 TYPE 'X' GYPSUM WALL BOARD FINISHED SEE ROOM FINISH SCHEDULE FOR DETAILS
- EXTERIOR VINYL SIDING GARAGE
 CONSTRUCTION AS PER W4; SUBSTITUTE INTERIOR GYPSUM BOARD WITH 6 DOUGLAS FIR PLYWOOD GARAGE SIDE
- EXTERIOR VINYL GARAGE 45 MIN. F.R.R. CONSTRUCTION AS PER W4a; ADD: 6 DOUGLAS FIR PLYWOOD GARAGE SIDE
- INTERIOR WALL 12.7 GYPSUM WALL BOARD 38X89 SPF NO 1/2 STUDS @ 406 O/C ROXUL SAFE & SOUND BATT (OPTIONAL) (38X140 SPF NO 1/2 STUDS @ 406 O/C WHERE REQUIRED FOR SERVICES) 12.7 GYPSUM WALL BOARD FINISHED SEE ROOM FINISH SCHEDULE FOR DETAILS
- CONSTRUCTION AS PER W5, ADD: 12 CEMENT BACKER BOARD (WASHROOM, LAUNDRY, LOCKER/SHOWER SIDE), POLYETHYLENE WATERPROOF MEMBRANE SHEET SYSTEM, TILE AS PER CLIENT
- INTERIOR WALL 45 MIN. F.R.R. CONSTRUCTION AS PER W4; SUBSTITUTE: GYPSUM BOARD BOTH FACES WITH 12.7 TYPE 'X' GYPSUM WALL BOARD FINISHED
- 45 MIN. F.R.R. O.B.C. SB-3 W1B 12.7 TYPE 'X' GYPSUM WALL BOARD FINISHED 38X140 SPF NO 1/2 STUDS @ 406 O/C 12.7 TYPE 'X' GYPSUM WALL BOARD FINISHED 9.5mm DOUGLAS FIR PLYWOOD GARAGE SIDE
- INTERIOR SHARED GARAGE WALL AT SHOWER 45 MIN. F.R.R. O.B.C. SB-3 W1B WALL CONSTRUCTION AS PER W6; ADD TO SHOWER SIDE: 12 CEMENT BACKER BOARD, POLYETHYLENE

(SCHUSTER, TILE AS PER CLIENT)

WATERPROOF MEMBRANE SHEET SYSTEM

OBC MATRIX


Item			Ontario's 2012 Building Code							OBC Reference				
ILEIII	Data Matrix Part 3 or 9									References are to Division B unless noted [A] for Division A or [C] for Division C				
1	Project				X N	lew		Part 11	□ Part	3	⊠ Part	9		
	Description	1:		Change of		Addition Alteration	11. ⁻		1.1.2. [A]		1.1.2. [A] 9.10.1.3	&		
2	Major Occ	upancy(s	s) – D (OFFIC	E) & F3 (GAR	AGE)		11.	4	3.1.2.1.(1)	9.10.2			
3	Building A		New 'GROU	JP D' - 133	Total 'GRC	OUP D' -133 OUP F3' -73		OTAL BUILDING REA = ± 206 SQ.M.	1.4.1.2.[<i>A</i>	, .]	1.4.1.2.[A]		
4	Gross Are (m²)	a	New 'GROU New 'GROU	JP D' – 133 JP F3' – 73	Total 'GRC Total 'GRC	OUP D' = 133 OUP F3' = 73	В	ASEMENT N.I.C.	1.4.1.2.[<i>A</i>	<u>']</u>	1.4.1.2.[A]		
5	Number o	f Storeys	5	Above Gro	ıde – 1	Below	Grade -	1	1.4.1.2.[<i>A</i>	3.2.1.1.	1.4.1.2.[A] & 9.10.4.		
6	Number o	f Streets	s/Fire Fighter	Access -	1				3.2.2.10.	& 3.2.5.	9.10.20.			
7	Building C	lassificat	ion – PA	RT 9 GROUP I	D / F3				3.2.2.71		9.10.2.			
8	General R	eview Re	quired			☐ Yes	X No		1.2.2.1.(1) [C] & Table	e 1.2.2.1. [C]			
9	Sprinklered System Proposed	d				☐ select	ed compar ed floor a u of roof r	reas	3.2.2. 3.2.1.5. SEE INDE 3.2.2.17. 3.2.1.5. 3.2.2.15		9.10.8.4. 9.10.8.2. 9.10.1.3.(3.2.2.15	3) &		
10	Standpipe	Require				□ Yes	X No		3.2.9.		N/A			
11	Fire Alarm	•				☐ Yes	■ No		3.2.4.		9.10.18			
12	 	· ·		-1-		✓ Yes	□ No		3.2.5.7.		N/A			
13	High Build	<u></u>	ply is Adequ	ute		□ Yes	■ No		3.2.6.		N/A			
14	Constructi Restriction	on			mbustible mitted		combustibl	e □ Both	3.2.2.		9.10.6.			
	Actual Co	nstructio	n	⊠ Cor	mbustible	□ Non−	combustibl	e □ Both						
15	Mezzanine	(s) Area	$(m^2) - 0$						3.2.1.1.(3	5)-(8)	9.10.4.1.			
16	Occupant Total			□ m² Occupa	/person ancy – D / F	☑ desigr 3 Loa	n of buildir d – 9 pe		3.1.17.		9.9.1.3.			
17	Barrier-Free 🗵 Yes Design			s 🗆 No				3.8. 3.8.1.1.(1)(c)		9.5.2. 3.8.1.1.(1)	9.5.2. 3.8.1.1.(1)(c)			
18	Hazardous	Substar	nces	Yes	s 🗵 No				3.3.1.2.	& 3.3.1.19.	9.10.1.3.(4)		
19	Required Fire Resistance Rating (FRR)	Required Fire FRR (hours) Resistance Rating Floors - 0.75 hours Listed Design No. or Description (SB-2 or SB-3) Description (SB-2 or SB-3) OBC SB-3 F6h					3.2.2. & 3.2.1.4.		9.10.8. 9.10.9.	7				
	FRR of Supporting Members					Design No. o	or or SB-3)							
			Floors - Roof - Mezzanine -	0.75 hours 0 hours - 0 hours	s	B-3 EW1B								
20a	Spatial Se	paration	- Construct	tion of New	Exterior Wo	ılls			3.2.3.					
	Wall	Area of EBF (m²		L/H or H/L	Permitted Max. % of Openings	Proposed % of Openings	FRR (hours)	Listed Design or Description		Comb Const	Comb Const Nonc. Cladding	Non-comb. Const		
	West	39.2	31.8	<3:1	100	100	0	N/A		x				
	East North	32.0 111.5		<3:1 3:1 TO 10:1	100	100	0	N/A OBC SB-3 EW1B (BASE		x x				
				1	84	77	0.75	DOOR/WIN. NOT RATE			frame 4: 1			
	South Elever			T -	Ī	1	T	D. line at 5.0m fron OBC SB-3 EW1B	n operation	s office 5.6m		nent plant		
	Main South 'D'	49.0		3:1 TO 10:1	41	12	0.75	DOOR / WIN. NOT RA	TED		X			
	Basement	8.9		>10:1	100	0	0	N/A OBC SB-3 EW1B		X				
21	South 'F2' Plumbing Fixture Requireme	30.6 ents	5.0		61 ND F - TOTAL TO SERVE B		0.75 OAD UNDEF	DOOR / WIN. NOT RA	TED	3.7.4.1.(3)	9.31	 .1.1.(2).(c) 4.1.(3)		

WINDOW SCHEDULE

1. EXTERIOR WINDOWS TO BE DOUBLE GLAZED, THERMALLY BROKEN.

2. INTERIOR WINDOWS TO BE TEMPERED SAFETY GLASS THICKNESS

TYPICAL GUARD

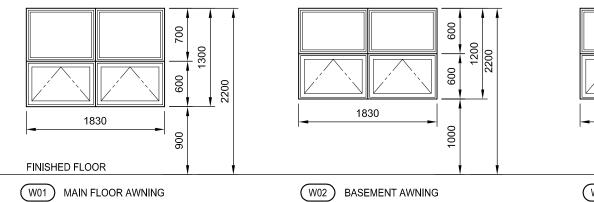

MIN. OPENING


NOSING


STAIRS AS PER O.B.C.


C/W SLIP RESISTANT FINISH

RISE AND RUN AS PER O.B.C. AND PLANS



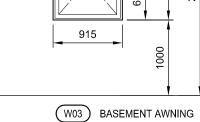


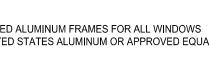

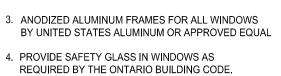

- MIN. HANDRAIL EXT.

BEYOND FIRST RISE

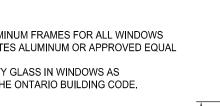

METAL TUBE

PER O.B.C.

HANDRAIL AS


300mm

MIN.

- HANDRAIL


EXTENSION

BEYOND STAIR

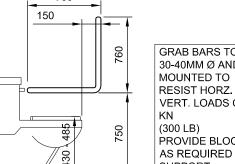

L-SHAPED GRAB BAR

BARRIER FREE DESIGN DETAILS

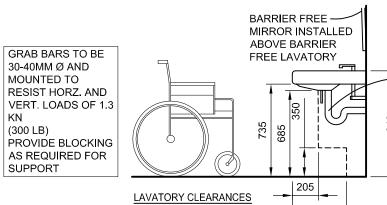

D. LOCKABLE E. PASSAGE SET

G. PUSH/PULL

KICK PLATE

J. DOOR STOP

L. THRESHOLD

M. SWEEP

F. PANIC HARDWARE

H. BARRIER FREE HARDWARE

K. WEATHER STRIPPING


N. KEY ACCESS FROM EXIT


O. WASHROOM SET (PRIVATE)


R. POWER DOOR OPERATOR

P. WIND LIMITER (INTEGRAL WITH CLOSER)

Q. UNIVERSAL BARRIER FREE SIGNAGE

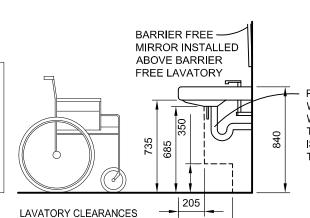

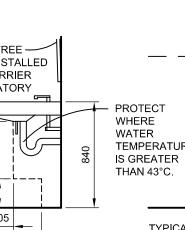

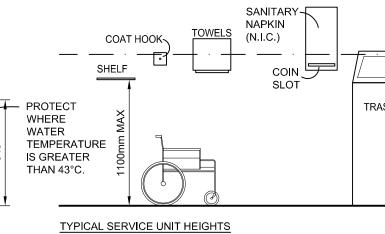



BARRIER-FREE ENTRY DOOR ASSEMBLY NOTES ENSURE A MAXIMUM DIFFERENCE IN ELEVATION OF 12mm AT NOTED BUILDING ENTRY DOOR NUMBER 101 & 104 TO ACCOMMODATE BARRIER-FREE ACCESSIBILITY INTO THE FACILITY. USE DESIGNATED BARRIER-FREE DOOR SILL;

BARRIER FREE ACCESSIBILITY NOTES:

- 1. WORK & ACCESSORIES REQUIRED TO "ACCESSIBLE" WASHROOMS: .1 PROVIDE ONE TILT MIRROR DESIGNATED AS "ACCESSIBLE"; 2 INSULATE WASTE & HOT WATER SUPPLY PIPING AT U/S OF LAVATORY;
- .6 ENSURE MINIMUM 300 CLEARANCE FROM JAMB TO OUT-SWING OF DOORS;
- 2. GRAB BARS TO ACCESSIBLE WASHROOM (ABLE TO SUPPORT 300 LB. CAPACITY):

- .3 WALL HUNG LAVATORY SHALL BE EQUIPPED WITH APPROVED "WING-HANDLED" TRIM; .4 MOUNT ALL FIXTURES AND ACCESSORIES AT AS INDICATED .5 ENSURE MINIMUM 600 CLEARANCE FROM JAMB TO IN-SWING OF DOORS;
- 7 PROVIDE COAT HOOK AT ELEVATION AS INDICATED
- .1 SIDE BAR TO BE MOUNTED AS INDICATE, PROVIDE SOLID BACK SUPPORT FOR ANCHORS. PROVIDE 50mm CLEAR BETWEEN .2 BACK BAR TO BE MOUNTED AS INDICATED, PROVIDE SOLID BACK SUPPORT FOR ANCHORS. PROVIDE 50mm CLEAR BETWEEN BAR AND WALL.

ROOM	FINISH	SCHEDU	JLE

	Τ	North	n Wall	Foot	: Wall	South	h Wall	Wood	t Wall		oor		iling	WD WOOD SHEATHING OR FRAMING PT PAINT (COLOUR TO BE SELECTED BY OWNER) PLY DOUGLAS FIR PLYWOOD CS CONCRETE FINISHED & SEALED WITH CHEMICAL SEALER/HARDNER TILE FLOOR TILE COLOUR/PATTERN AS PER CLIENT VCT RESILIENT TILE FLOORING (VINYL COMPOSITION TILE) COLOUR/PATTERN AS PER CLIENT RBR COMMERCIAL RUBBER (COLOUR AS PER CLIENT)
No.	Room Name	Material	Finish	Material	Finish	Material		Material		Material		Material	Finish	Comments
101	COMMON OFFICE	GWB	PT	GWB	PT	GWB	PT	GWB	PT	VCT	CLIENT	GWB	PT	Comments
101	COMMON OFFICE	GWB	FI	GWB	FI	GWB	FI	GWB	FI	VCI	CLIENT	GVVB	FI	
102	LUNCH ROOM	GWB	PT	GWB	PT	GWB	PT	GWB	PT	VCT	CLIENT	GWB	PT	
103	STAIR	GWB.X	PT	GWB.X	PT	GWB.X	PT	GWB.X	PT	RBR	CLIENT	GWB.X	PT	COMMERCIAL RUBBER ROLL FLOORING LANDINGS & STAIR TREADS / RISE
104	HALL	GWB	PT	GWB	PT	GWB	PT	GWB	PT	VCT	CLIENT	GWB	PT	
105	OFFICE	GWB	PT	GWB	PT	GWB.X	PT	GWB	PT	VCT	CLIENT	GWB	PT	
106	ENTRY	GWB	PT	GWB	PT	GWB.X	PT	GWB	PT	VCT	CLIENT	GWB	PT	
107	UNIVERSAL W/R	GWB	PT	GWB	PT	GWB.X	PT	GWB	PT	VCT	CLIENT	GWB	PT	
108	LAUNDRY	GWB	TILE/PT	GWB	TILE/PT	GWB.X	TILE/PT	GWB	TILE/PT	TILE	CLIENT	GWB	PT	TILE TO 1400 A.F.F., TILE WALL BASE, TILE OVER MEMBRANE FLOOR SYSTE
109	LOCKER	GWB	TILE/PT	GWB	TILE/PT	GWB.X	TILE/PT	GWB	TILE/PT	TILE	CLIENT	GWB	PT	TILE TO 1400 A.F.F., TILE WALL BASE, TILE OVER MEMBRANE FLOOR SYSTE
110	SHOWER	GWB	TILE	GWB	TILE	GWB.X	TILE	GWB	TILE	TILE	CLIENT	GWB	PT	FULL TILE WALLS, TILE WALL BASE, MEMBRANE FLOOR & WALL SYSTEM
111	SINGLE TRUCK BAY	PLY	-	PLY	-	-	-	GWB.X PLY	-	CONC	cs	GWB.X	PT	F.R.R. ON SOUTH & WEST WALL REQUIRE GYPSUM BOARD UNDER PLYWO
112	SINGLE TRUCK BAY	-	-	PLY	-	GWB.X PLY	-	GWB.X PLY	-	CONC	cs	GWB.X	PT	F.R.R. ON SOUTH & WEST WALL REQUIRE GYPSUM BOARD UNDER PLYWO
001	UNFINISHED BASEMENT	GWB.X	PT	GWB.X	PT	-	-	GWB.X	PT	CONC	cs	GWB.X	PT	

GWB.X PT GWB.X PT GWB.X PT CONC CS GWB.X PT

- SEE WALL SCHEDULE FOR FURTHER DETAILS


002 MECHANICAL AREA


- FINAL FINISH MATERIALS TO BE CONFIRMED BY CLIENT PRIOR TO CONSTRUCTION

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TYPICAL CONTROLS FOR OPERATION OF BUILDING

THERMOSTAT FIRE ALARM

PULL STATION

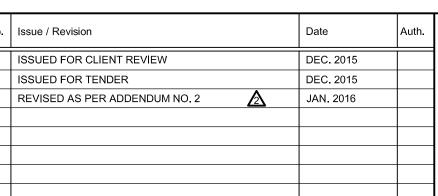CONTROL

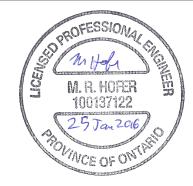SWITCH ELEVATOR




R.J. Burnside & Associates Limited 292 Speedvale Ave. W., Unit 20 Guelph, Ontario, N1H 1C4 telephone (519) 823-4995 fax (519) 836-5477 web www.rjburnside.com

ALMA ST. WASTEWATER PRETREATMENT FACILITY UPGRADES SCHEDULES & DETAILS

ROOM FINISH LEGEND

TOWNSHIP OF GUELPH / ERAMOSA 8348 WELLINGTON ROAD 124, P.O. BOX 700 ROCKWOOD, ON N0B 2K0

M.H. | T.T. M.H. JAN. 2015 Revision No. MSA143810.0062 MSA143810.0062 Scale AS NOTED

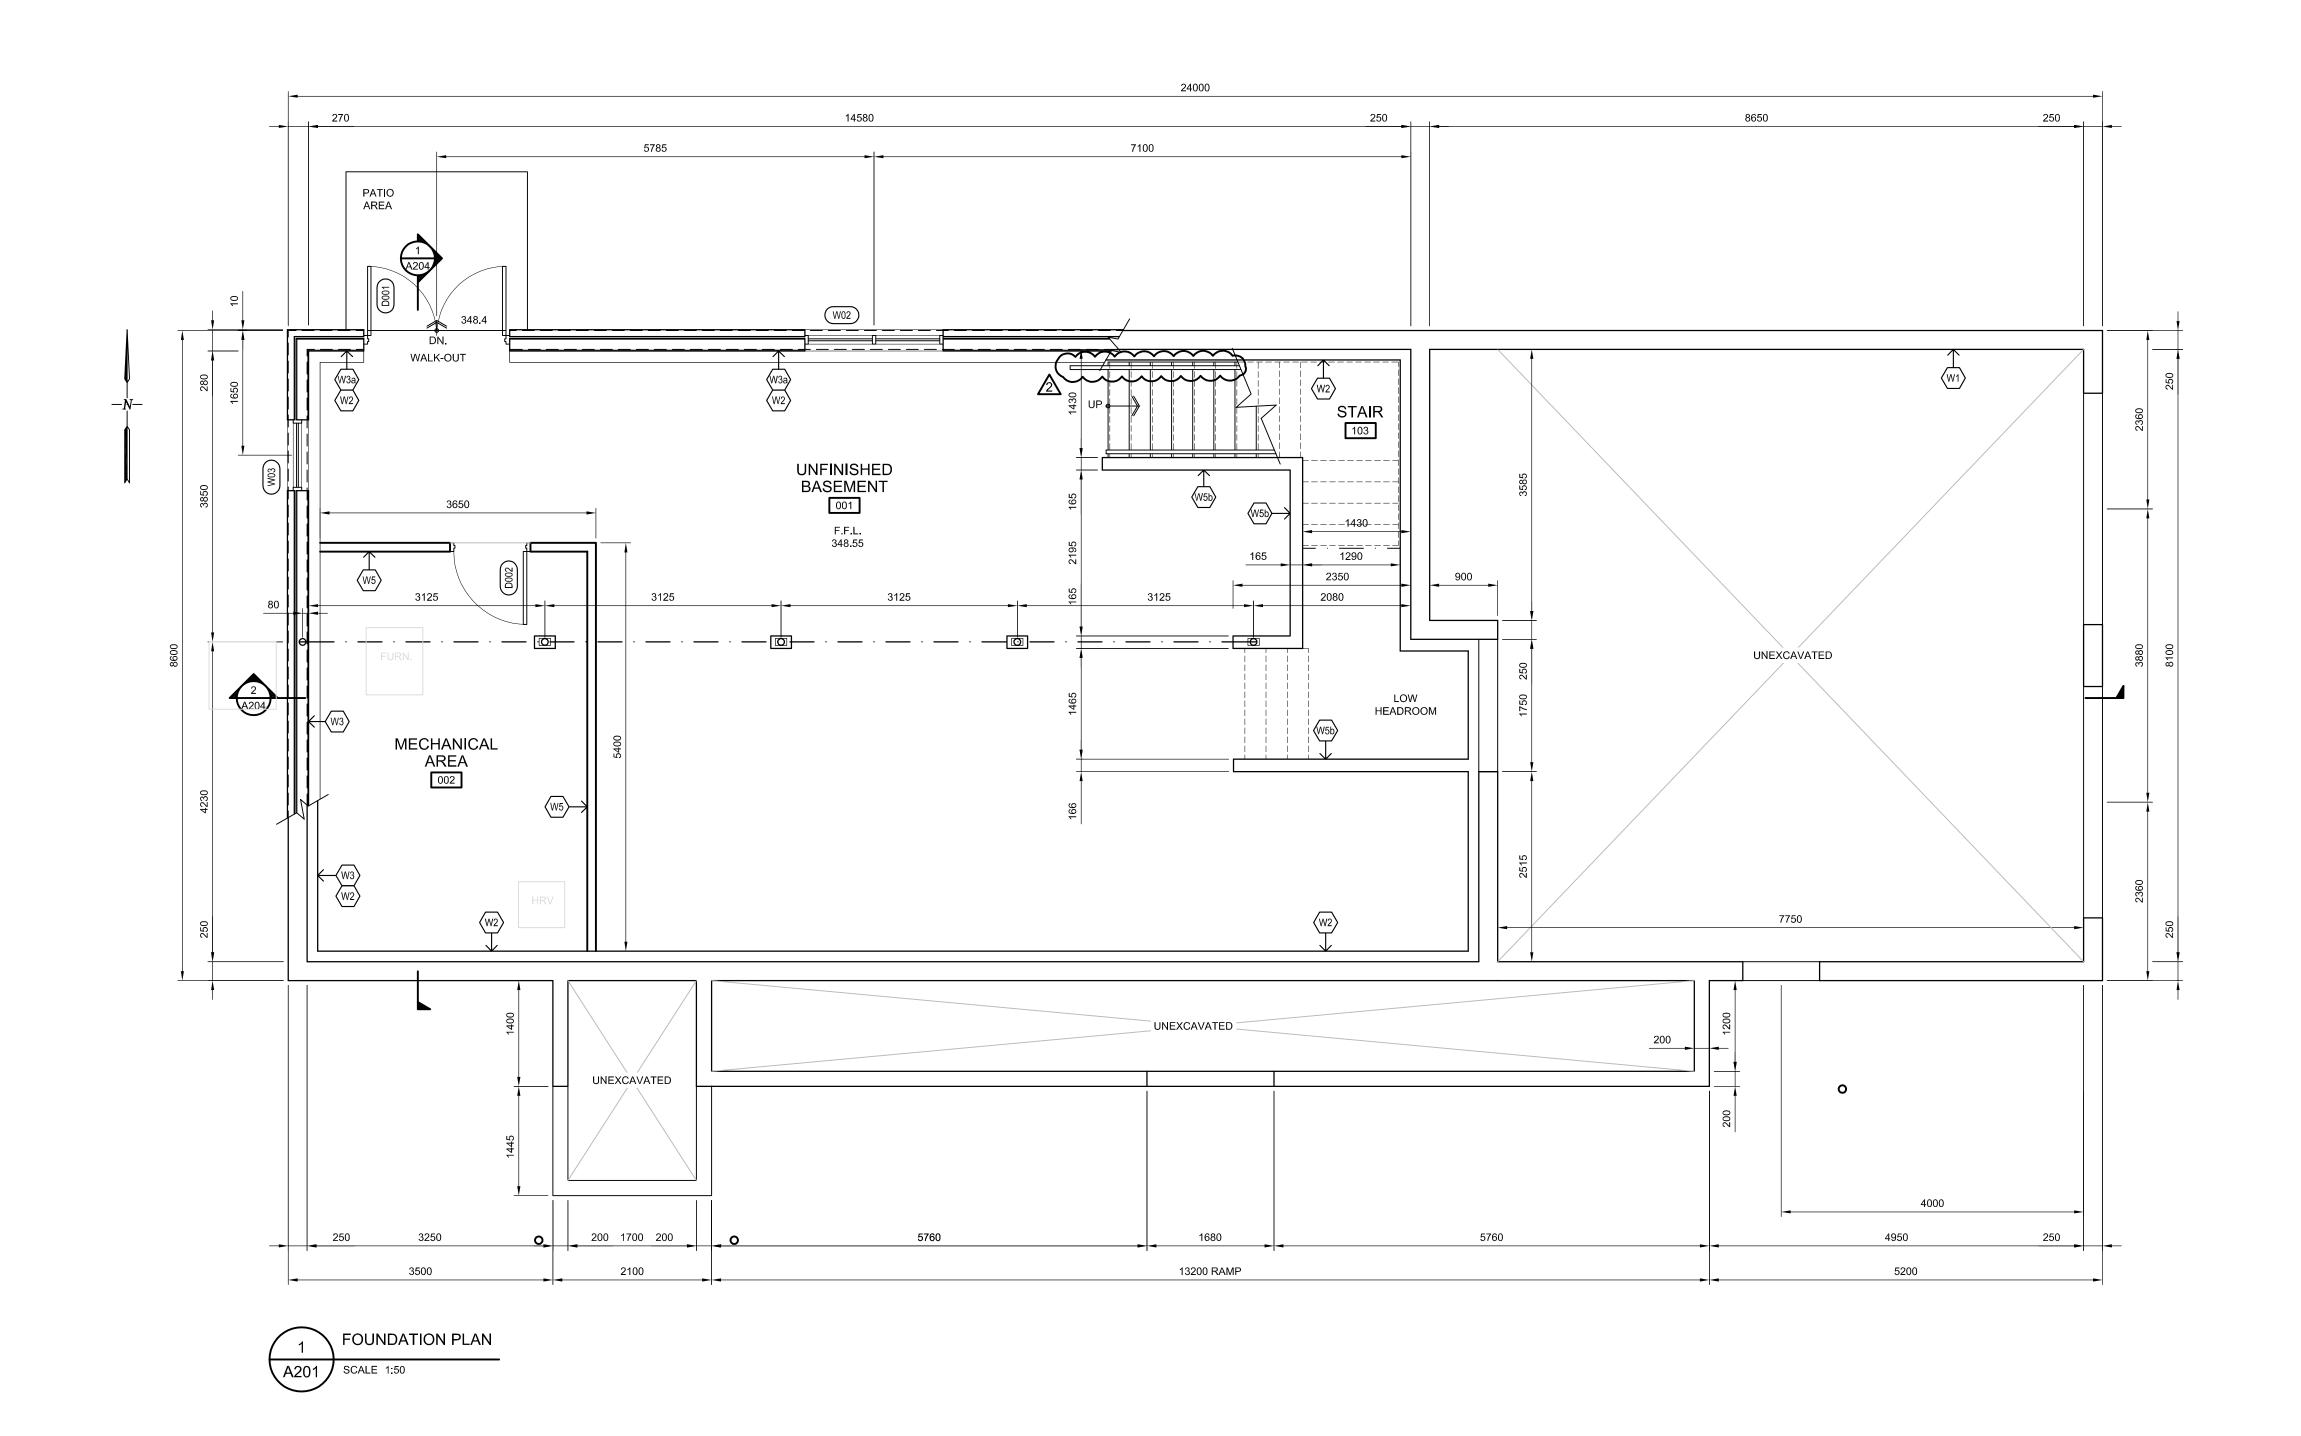

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3	 This drawing is to be read and understood in conjunction with all other plans and documents applicable to this project. 	ŀ

No. Issue / Revision Date Auth.

1 ISSUED FOR CLIENT REVIEW DEC. 2015
2 ISSUED FOR TENDER DEC. 2015
3 REVISED AS PER ADDENDUM NO. 2 AND JAN. 2016

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ALMA ST. WASTEWATER PRETREATMENT
FACILITY UPGRADES
ARCHITECTUAL FOUNDATION FLOOR PLAN

TOWNSHIP OF GUELPH / ERAMOSA

8348 WELLINGTON ROAD 124, P.O. BOX 700
ROCKWOOD, ON
N0B 2K0


 Drawn
 Checked
 Designed
 Checked
 Date
 Drawing No.

 T.T.
 M.H.
 T.T.
 M.H.
 JAN. 2015

 Project No.
 Contract No.
 Revision No.

 MSA143810.0062
 2

 Scale
 AS NOTED

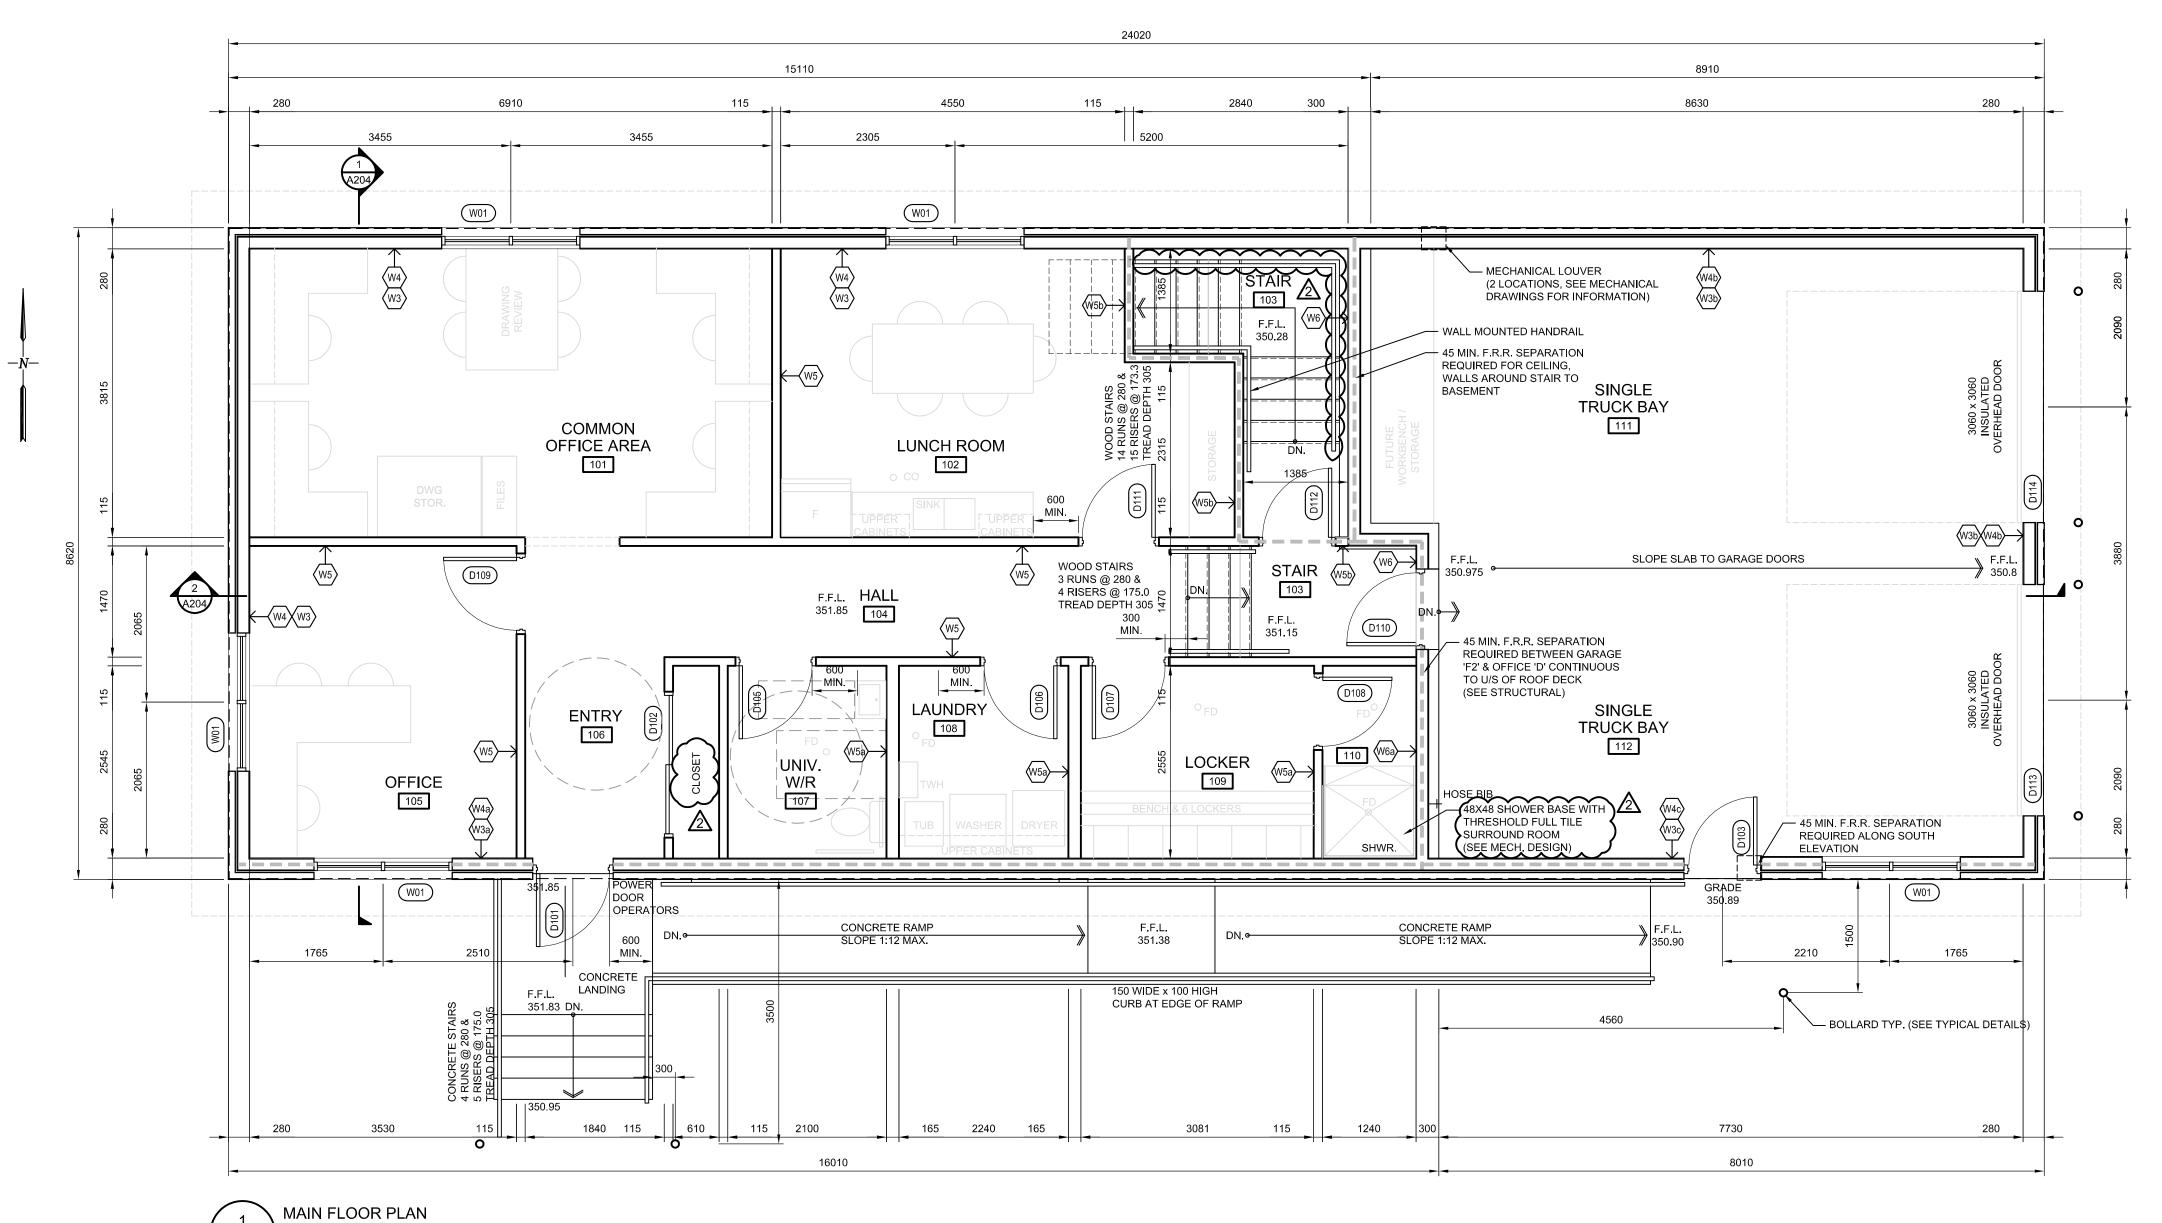

A202 SCALE 1:50

GROUP D OFFICE AREA = ± 133 sq.m.

GROUP D OFFICE AREA = ± 133 sq.m.
GROUP F2 GARAGE = ± 73 sq.m.
TOTAL BUILDING AREA = ± 206 sq.m.

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FOR TENDER

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I ISSUED FOR CLIENT REVIEW DEC. 2015

ISSUED FOR TENDER DEC. 2015

REVISED AS PER ADDENDUM NO. 2 JAN. 2016

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ALMA ST. WASTEWATER PRETREATMENT
FACILITY UPGRADES
ARCHITECTURAL MAIN FLOOR PLAN

TOWNSHIP OF GUELPH / ERAMOSA

8348 WELLINGTON ROAD 124, P.O. BOX 700
ROCKWOOD, ON
N0B 2K0


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 Designed
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 Date
 Drawing No.

 T.T.
 M.H.
 T.T.
 M.H.
 JAN. 2015

 Project No.
 Contract No.
 Revision No.

 MSA143810.0062
 2

 Scale
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FOR TENDER

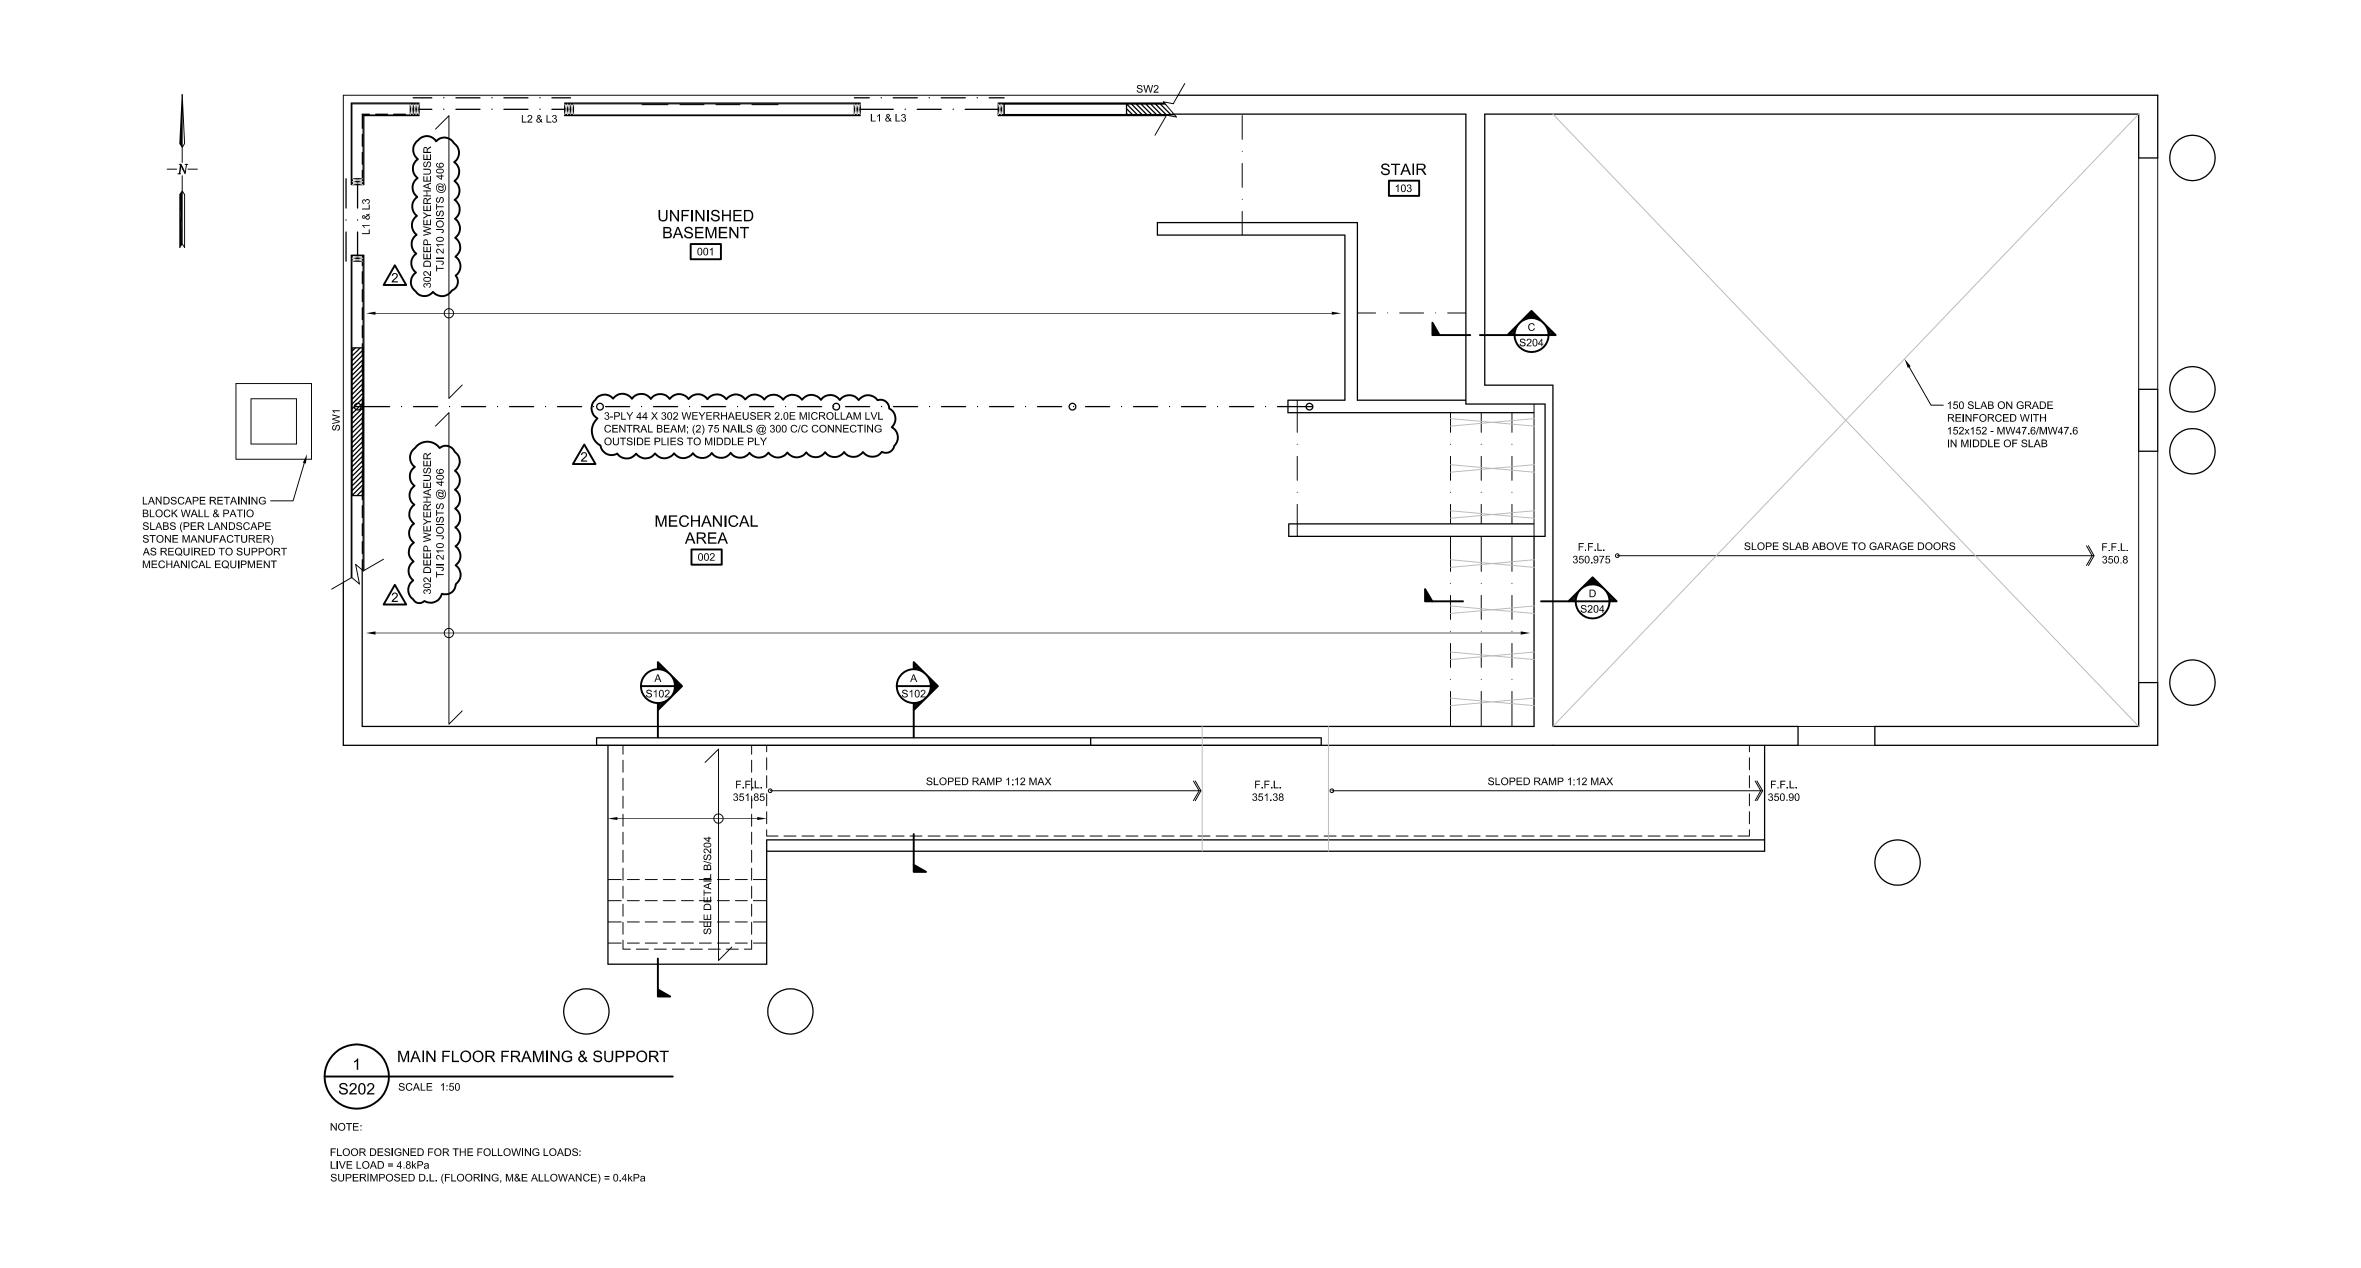No. Issue / Revision Date And Issue / Revision Date And Issued FOR CLIENT REVIEW DEC. 2015

2 ISSUED FOR TENDER DEC. 2015

3 REVISED AS PER ADDENDUM NO. 2 And DEC. 2016

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ALMA ST. WASTEWATER PRETREATMENT
FACILITY UPGRADES
STRUCTURAL MAIN FLOOR SUPPORT

TOWNSHIP OF GUELPH / ERAMOSA


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ROCKWOOD, ON
N0B 2K0

 Drawn
 Checked
 Designed
 Checked
 Date
 Drawing No.

 T.T.
 M.H.
 C.S.
 M.H.
 JAN. 2015

 Project No.
 Revision No.
 Revision No.

 MSA143810.0062
 MSA143810.0062
 2

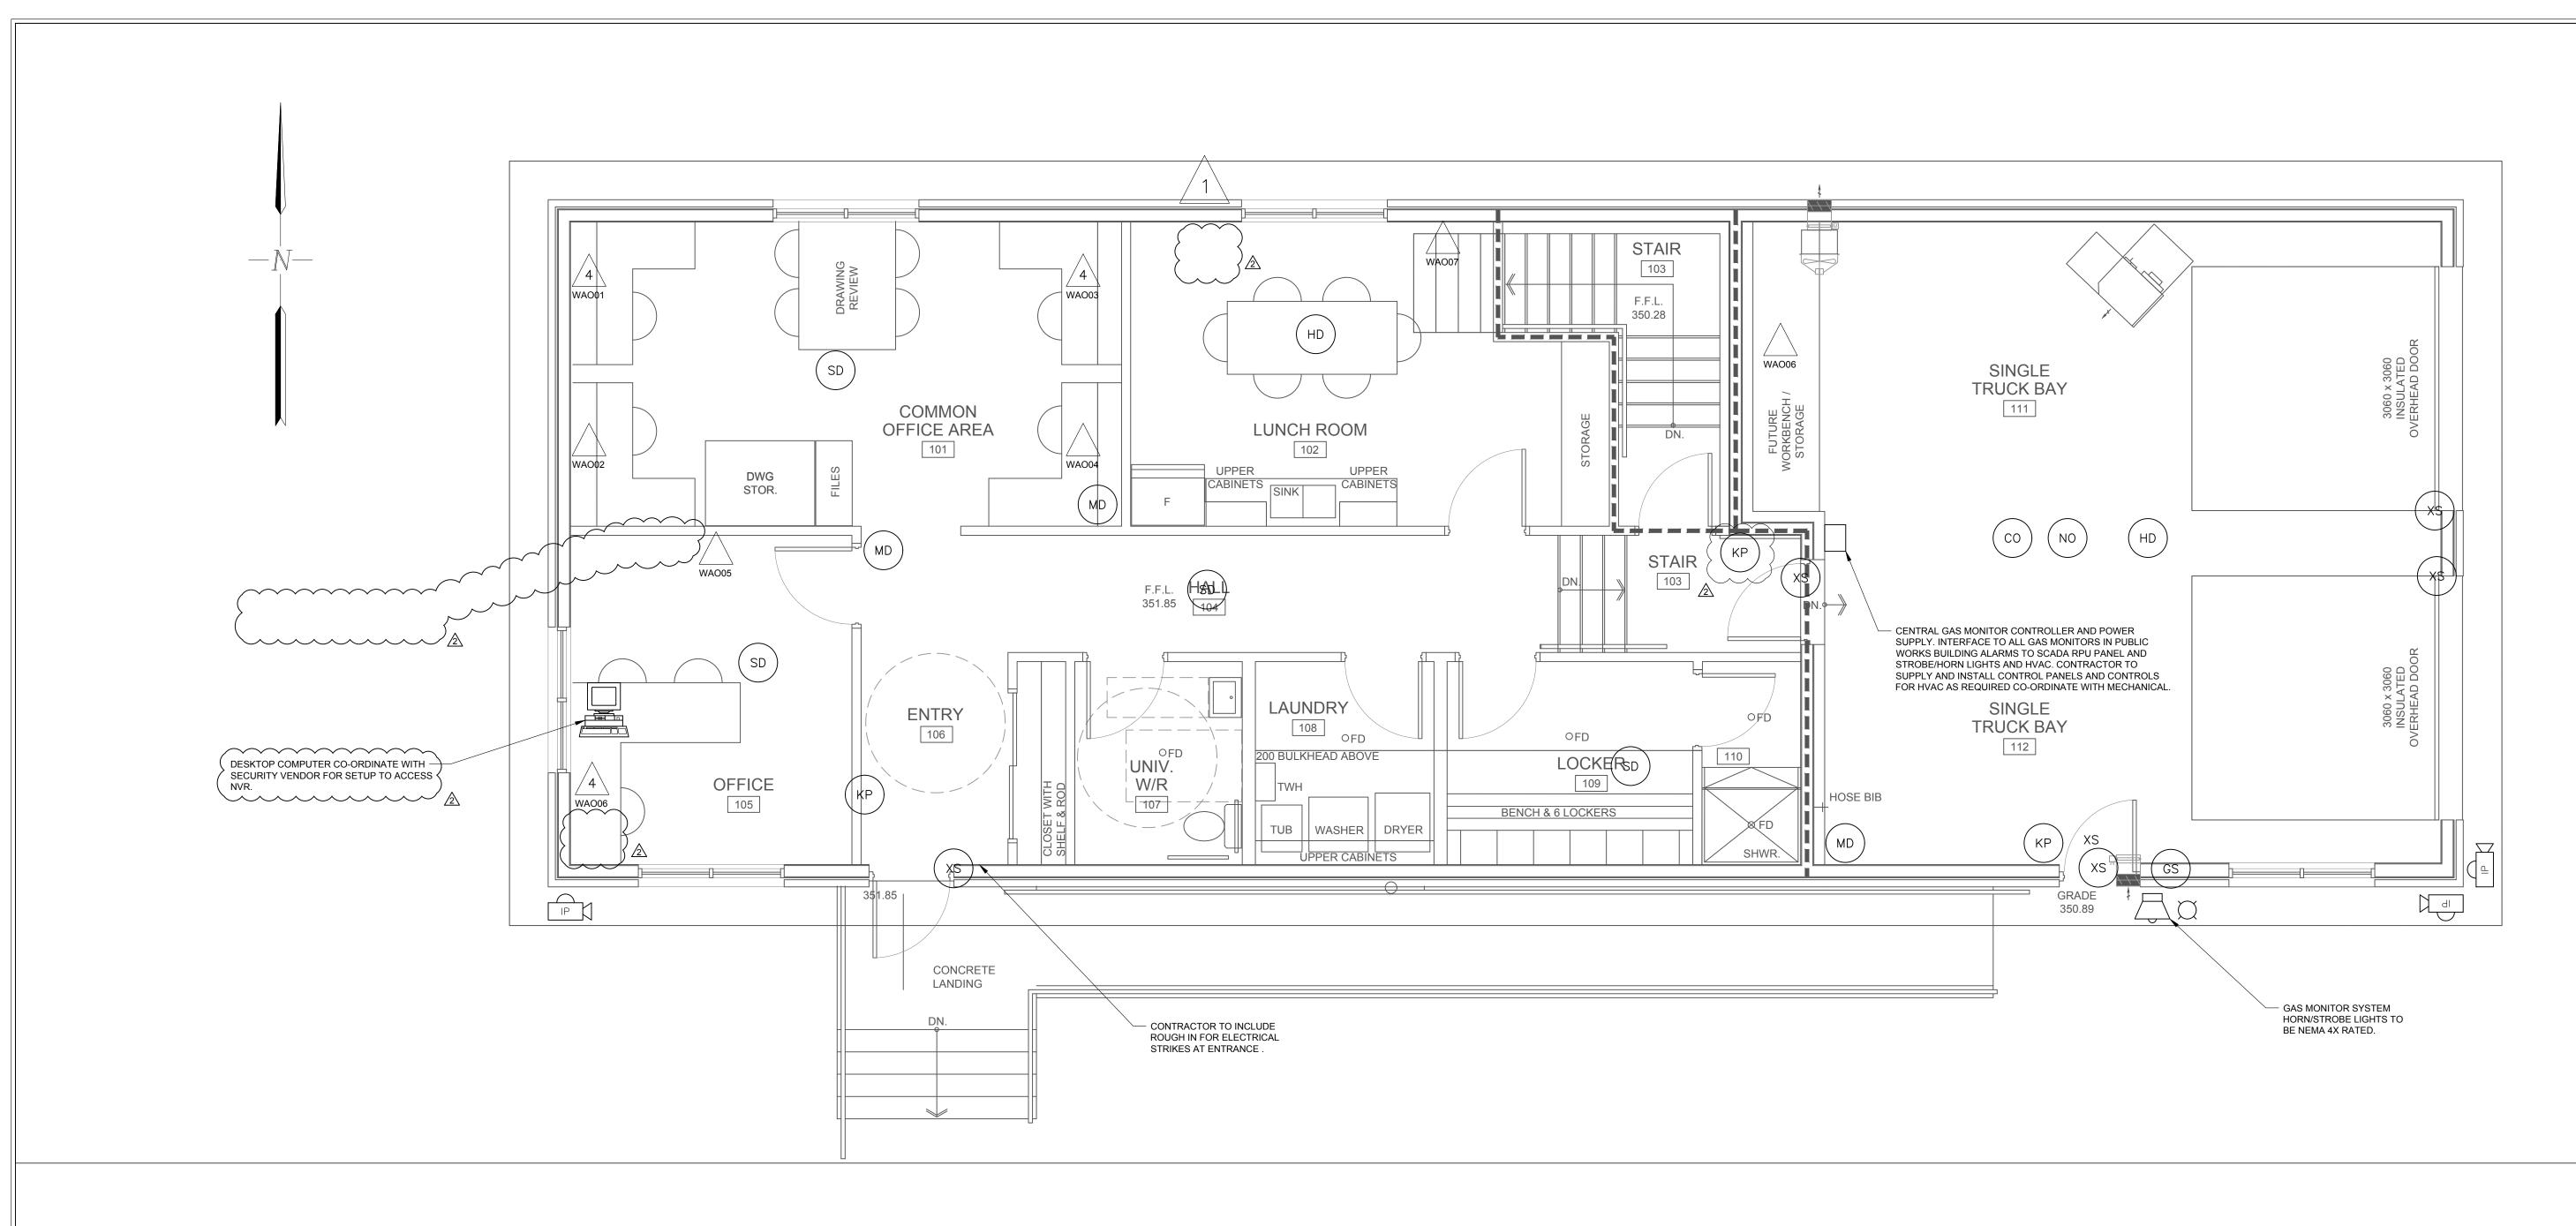

MAIN FLOOR I&C PLAN

LEGEND			
TYPE	MANUFACTURER	TYPE	MANUFACTURER
	2 PORT WORK AREA OUTLET	4	4 PORT WORK AREA OUTLET
SD	SMOKE DETECTOR	HD	HEAT DETECTOR
КР	SECURITY KEYPAD	IP	IP CAMERA
GS	GLASS BREAK SENSOR	CO	CARBON MONOXIDE DETECTOR (NOTE 5)
MD	MOTION DETECTOR	NO	NITROGEN DIOXIDE (NOTE 5)
XS	DOOR CONTACT		

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2	The contractor shall verify all dimensions, levels, and datums on site and report any discrepancies

The contractor shall verify all dimensions, levels, and datums on site and report any discrepancies or omissions to this office prior to construction.

3. This drawing is to be read and understood in conjunction with all other plans and documents applicable to this project.

FOR TENDER

f	No.	Issue / Revision	Date	Auth
s	1	ISSUED FOR MOECC ECA	FEB. 2015	JW
	2	ISSUED FOR 90% REVIEW	OCT. 2015	JW
	3	ISSUED FOR TENDER	DEC. 2015	JW
	4	REVISED AS PER ADDENDUM No. 2	JAN. 2016	JW

NOTE:

1. ALL ELECTRICAL WORK, WIRING METHOD, EQUIPMENT AND INSTALLATION SHALL COMPLY WITH THE LATEST EDITION OF THE ONTARIO ELECTRICAL SAFETY CODE.

1. ALL ELECTRICAL SAFETY CODE.

1. ALL ELECTRICAL SAFETY CODE.

2. ALL ELECTRICAL SAFETY CODE.

2. ALL ELECTRICAL SAFETY CODE. 2. ALL DOOR CONTRACTS GLASS BREAK SENSORS, SMOKE DETECTORS MOTION AND SECURITY KEYPADS TO BE SUPPLIED BY SECURITY SYSTEMS VENDOR. INSTALLATION IN THE FIELD WITH WIRING AND CONDUIT BACK TO MAIN SECURITY PANEL TO BE BY

THE CONTRACTOR. CO-ORDINATE WITH VENDOR AS REQUIRED FOR ALL INSTALLATION AND TESTING. ALL CAT6 CABLING FOR PHONE AND DATA TO BE ROUTED IN GROUNDED RIGID CONDUIT TO BASEMENT DEMARCATION POINT AND
TERMINATED ON PATCH PANEL FOR SECURITY CAMERAS LOCATIONS WITH ROUTING AND CAT6 CABLING ROUTED TO BASEMENT.
 ROUTE IN FOR IP CAMERAS TO BE MOUNTED APPROXIMATELY 3048mm FROM GRADE. CONFIRM WITH SECURITY SUPPLIER ON SITE.

5. CARBON MONOXIDE AND NITROGEN DIOXIDE DETECTORS PANELS, LIGHTS, HORNS, ETC. SUPPLIED AS PER M201. ROUTE ALARM CONTACTS BACK TO RPU PANEL IN TREATMENT PLANT AND NOT THE SECURITY SYSTEM.

_	1
ERAMOSA	

BURNSIDE

8348 WELLINGTON ROAD 124, P.O. BOX 700 ROCKWOOD, ON

N0B 2K0

R.J. Burnside & Associates Limited 292 Speedvale Ave. W., Unit 20 Guelph, Ontario, N1H 1C4 telephone (519) 823-4995

ALMA ST. WASTEWATER PRETREATMENT FACILITY UPGRADES PUBLIC WORKS BUILDING

fax (519) 836-5477 MAIN FLOOR I&C FLOOR PLAN TOWNSHIP OF GUELPH / ERAMOSA

Drawn	Checked	Designed	Checked	Date	Drawing No.
AA	S.M.	E.Y.	J.W.	OCT 2015	
Project No.		Contract No.		Revision No.	1004
MSA143810.0062		MSA143810.0062		1	 1201
Scale NOT TO SCALE					