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U/S MAIN FLOOR ADDITION SUNROOM CEILING

U/S MAIN FLOOR ADDITION DROPPED CEILING

TOP OF MAIN FLOOR SUBFLOOR TOP OF FOUNDATION WALL

TOP OF ADDITION FOOTING

LEFT ELEVATION



(519) 669-4780

ELMIRA, ONTARIO

PROPOSED ADDITION NOTES

CONCRETE NOTES

FRAMING NOTES

GENERAL NOTES

THE PROPOSED CONSTRUCTION CONSISTS OF:

TO THE REAR OF THE SUNROOM ADDITION C/W A CONCRETE PERIMETER WALL FOUNDATION BELOW.

ADDING A NEW 435 SQ,FT, LOWER LEVEL SUNROOM ADDITION TO THE REAR OF THIS EXISTING DWELLING C/W
A CONCRETE CRAWLSPACE FOUNDATION BELOW,

ALL ADDITION FOUNDATION WALLS TO BE 8" POURED CONCRETE C/W 6" x20" CONCRETE FOOTINGS.

I KING) UNLESS OTHERWISE NOTED. TRUSSED ROOF AS PER MANUFACTURERS' SPECIFICATIONS. ROOF OVER FRAME RAFTERS TO BE 2"x6" @ 16" O.C. C/W 2"x4" COLLAR TIES AS REQUIRED UNLESS OTHERWISE NOTED. RIDGE, HIP AND VALLEY RAFTERS TO BE 2"XIO" WITH

ALL STEEL BEAMS & HSS COLUMNS TO BE GRADE 350W
ALL LUMBER TO BE SPF NO. 1/2 OR BETTER MINIMUM SOIL

PROVIDE SOLID BLOCKING @ WALLS ADJACENT TO WATER

CLOSETS TO FACILITATE FUTURE WATER CLOSET GRAB BARS

USE (3) 2"x8" HEADERS C/W 2-2x6 POSTS (1 JACK +

SUPPORT AS REQUIRED UNLESS OTHERWISE NOTED.

BEARING CAPACITY TO BE 100KPa (2000psf)

, ADDING A NEW 2T'-6"  $\times$  12'-0" COVERED PORCH ADDITION

CRAIG.FREDE@SYMPATICO.CA

CONTRACTORS NOTE CONTRACTOR SHALL CHECK ALL DIMENSIONS ON THE DRAWINGS AND REPORT ANY DISCREPANCIES TO THE DESIGNER BEFORE PROCEEDING DRAWINGS ARE NOT TO BE SCALED

THE UNDERSIGNED HAS REVIEWED AND TAKES RESPONSIBILITY FOR THIS DESIGN, AND HAS THE QUALIFICATIONS AND MEETS THE REQUIREMENTS SET OUT IN THE ONTARIO BUILDING CODE TO BE A DESIGNER.

CRAIG FREDE

U/S SECOND FLOOR CEILING

TOP OF SECOND FLOOR SUBFLOOR

TOP OF MAIN FLOOR SUBFLOOR

TOP OF FOUNDATION WALL

\_\_\_\_\_\_TOP\_OF\_FOOTING

U/6 MAIN FLOOR CEILING

C. FREDE DESIGN INC. BCIN # 41306

BCIN # 20343



CUSTOM RESIDENTIAL ELMIRA, ONTARIO (519) 669-1217


### SPRAGGETT RES.

ROCKWOOD

ONTARIO

FRONT & LEFT ELEVATIONS

DRAWN	SCALE	DRAWING NO:
C.F.	3/16"=1'-0"	
DATE	FILE NO:	<del> </del>
MAY 18, 2021	600-100-21	

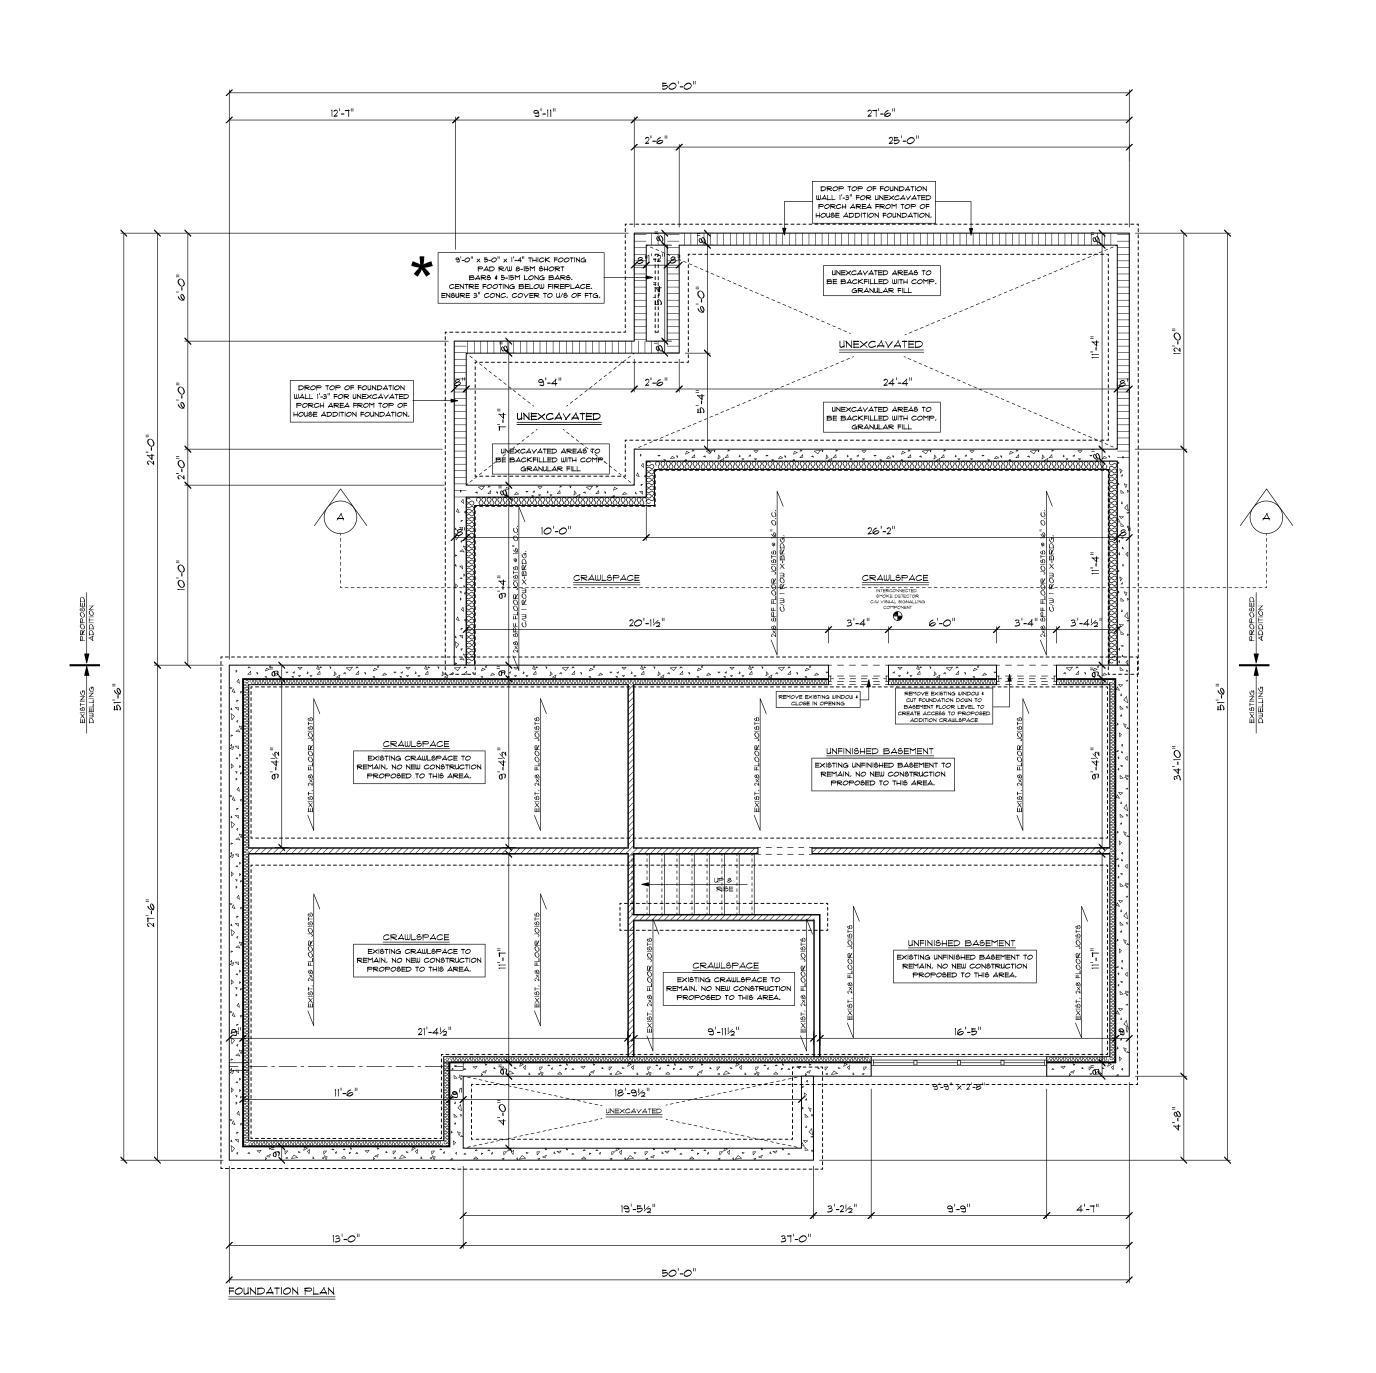

THE PROPOSED CONSTRUCTION CONSISTS OF: , ADDING A NEW 435 SQ.FT, LOWER LEVEL SUNROOM ADDITION TO THE REAR OF THIS EXISTING DWELLING C/W A CONCRETE CRAWLSPACE FOUNDATION BELOW, 2. ADDING A NEW 21'-6"  $\times$  12'-0" COVERED PORCH ADDITION TO THE REAR OF THE SUNROOM ADDITION C/W A CONCRETE PERIMETER WALL FOUNDATION BELOW. CONCRETE NOTES

ALL ADDITION FOUNDATION WALLS TO BE 8" POURED CONCRETE C/W 6"x20" CONCRETE FOOTINGS.

#### FRAMING NOTES

USE (3) 2"x8" HEADERS C/W 2-2x6 POSTS (1 JACK + 1 KING) UNLESS OTHERWISE NOTED. TRUSSED ROOF AS PER MANUFACTURERS' SPECIFICATIONS. ROOF OVER FRAME RAFTERS TO BE 2"X6" @ 16" O.C. C/W 2"x4" COLLAR TIES AS REQUIRED UNLESS OTHERWISE NOTED. RIDGE, HIP AND VALLEY RAFTERS TO BE 2"XIO" WITH SUPPORT AS REQUIRED UNLESS OTHERWISE NOTED.

#### GENERAL NOTES

K.D. SIMONDS

100197840

May 18, 2021 TE-37651-21

ALL STEEL BEAMS & HSS COLUMNS TO BE GRADE 350W ALL LUMBER TO BE SPF NO. 1/2 OR BETTER MINIMUM SOIL BEARING CAPACITY TO BE 100KPa (2000psf) PROVIDE SOLID BLOCKING @ WALLS ADJACENT TO WATER CLOSETS TO FACILITATE FUTURE WATER CLOSET GRAB BARS

## \* ITEMS DESIGNED AS REQUESTED.

UNFACTORED DESIGN LOADS:

LIVE: SNOW = 1.61 kPa (Ss= 2.2kPa) OCCUPANCY = 1.9 kPa

DEAD: ROOF = 0.75 kPa

FLOOR = 0.57 kPa

STONE VENEER = 2.4 kPa

BLOCK MASONRY = 4.8 kPa

TAC MA

ASSUMED MIN. 100 kPa ALLOWABLE SOIL BEARING CAPACITY.

## C. FREDE DESIGN INC.

(519) 669-4780

ELMIRA, ONTARIO CRAIG.FREDE@SYMPATICO.CA

CONTRACTORS NOTE CONTRACTOR SHALL CHECK ALL DIMENSIONS ON THE DRAWINGS AND REPORT ANY DISCREPANCIES

DRAWINGS ARE NOT TO BE SCALED

TO THE DESIGNER BEFORE PROCEEDING

THE UNDERSIGNED HAS REVIEWED AND TAKES RESPONSIBILITY FOR THIS DESIGN, AND HAS THE QUALIFICATIONS AND MEETS THE REQUIREMENTS SET OUT IN THE ONTARIO BUILDING CODE TO BE A DESIGNER. CRAIG FREDE BCIN # 20343

BCIN # 41306

C. FREDE DESIGN INC.

# CONSTRUCTION

LTD, CUSTOM RESIDENTIAL ELMIRA, ONTARIO (519) 669-1217


### SPRAGGETT RES.

ROCKWOOD

ONTARIO

### FOUNDATION PLAN

DRAWN	SCALE	DRAWING NO:
C.F.	3/16"=1'-0"	
DATE	FILE NO:	<del>A</del> -2
MAY 18, 2021	600-100-21	

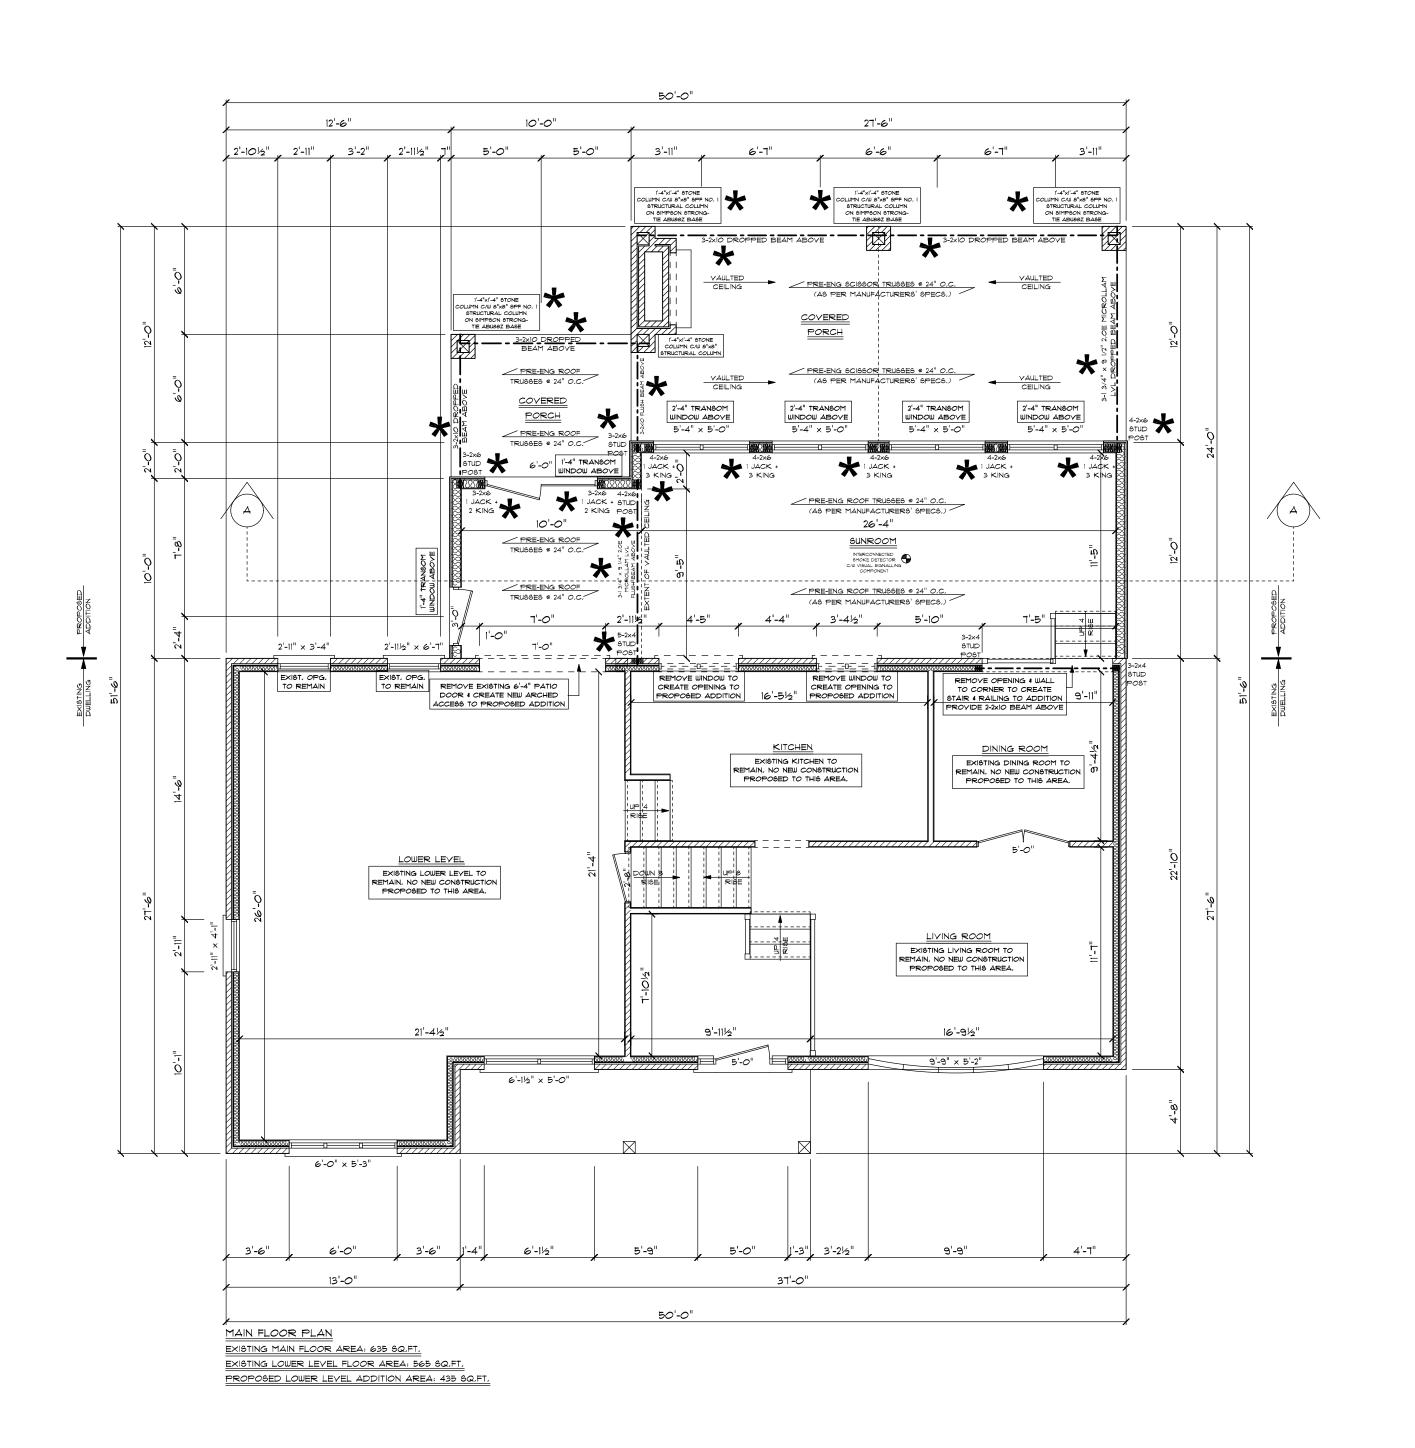

THE PROPOSED CONSTRUCTION CONSISTS OF:

1. ADDING A NEW 435 SQ.FT, LOWER LEVEL SUNROOM
ADDITION TO THE REAR OF THIS EXISTING DWELLING C/W

ADDITION TO THE REAR OF THIS EXISTING DWELLING C/W
A CONCRETE CRAWLSPACE FOUNDATION BELOW.

2. ADDING A NEW 21'-6" x 12'-0" COVERED PORCH ADDITION

A CONCRETE PERIMETER WALL FOUNDATION BELOW.

CONCRETE NOTES

ALL ADDITION FOUNDATION WALLS TO BE 8" POURED CONCRETE C/W 6"x20" CONCRETE FOOTINGS,
FRAMING NOTES

USE (3) 2"x8" HEADERS C/W 2-2x6 POSTS (1 JACK +

TO THE REAR OF THE SUNROOM ADDITION C/W

I KING) UNLESS OTHERWISE NOTED.

TRUSSED ROOF AS PER MANUFACTURERS' SPECIFICATIONS,

ROOF OVER FRAME RAFTERS TO BE 2"x6" © 16" O.C. C/W

2"x4" COLLAR TIES AS REQUIRED UNLESS OTHERWISE NOTED.

RIDGE, HIP AND VALLEY RAFTERS TO BE 2"x10" WITH

SUPPORT AS REQUIRED UNLESS OTHERWISE NOTED.

GENERAL NOTES

ALL STEEL BEAMS & HSS COLUMNS TO BE GRADE 350W

ALL LUMBER TO BE SPF NO. 1/2 OR BETTER MINIMUM SOIL

BEARING CAPACITY TO BE IOOKPA (2000psf)
PROVIDE SOLID BLOCKING ® WALLS ADJACENT TO WATER
CLOSETS TO FACILITATE FUTURE WATER CLOSET GRAB BARS

## \* ITEMS DESIGNED AS REQUESTED.

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OCCUPANCY = 1.9 kPa

DEAD: ROOF = 0.75 kPa

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May 18, 2021

TE-37651-21

FLOOR = 0.57 kPa STONE VENEER = 2.4 kPa

 $\frac{\text{BLOCK MASONRY} = 4.8 \text{ kPa}}{TAC \bigcirc MA}$ 

ASSUMED MIN. 100 kPa ALLOWABLE

SOIL BEARING CAPACITY.

# C. FREDE DESIGN INC.

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BCIN # 20343

BCIN # 41306

CRAIG FREDE

C. FREDE DESIGN INC.

## R.P.M. CONSTRUCTION

CUSTOM RESIDENTIAL ELMIRA, ONTARIO (519) 669-1217

#### SPRAGGETT RES.


ROCKWOOD


ONTARIO

DRAWING TITLE

## MAIN FLOOR PLAN

DRAWN	6CALE	DRAWING NO:
C.F.	3/16"=1'-0"	
DATE	FILE NO:	A-3
MAY 18, 2021	600-100-21	

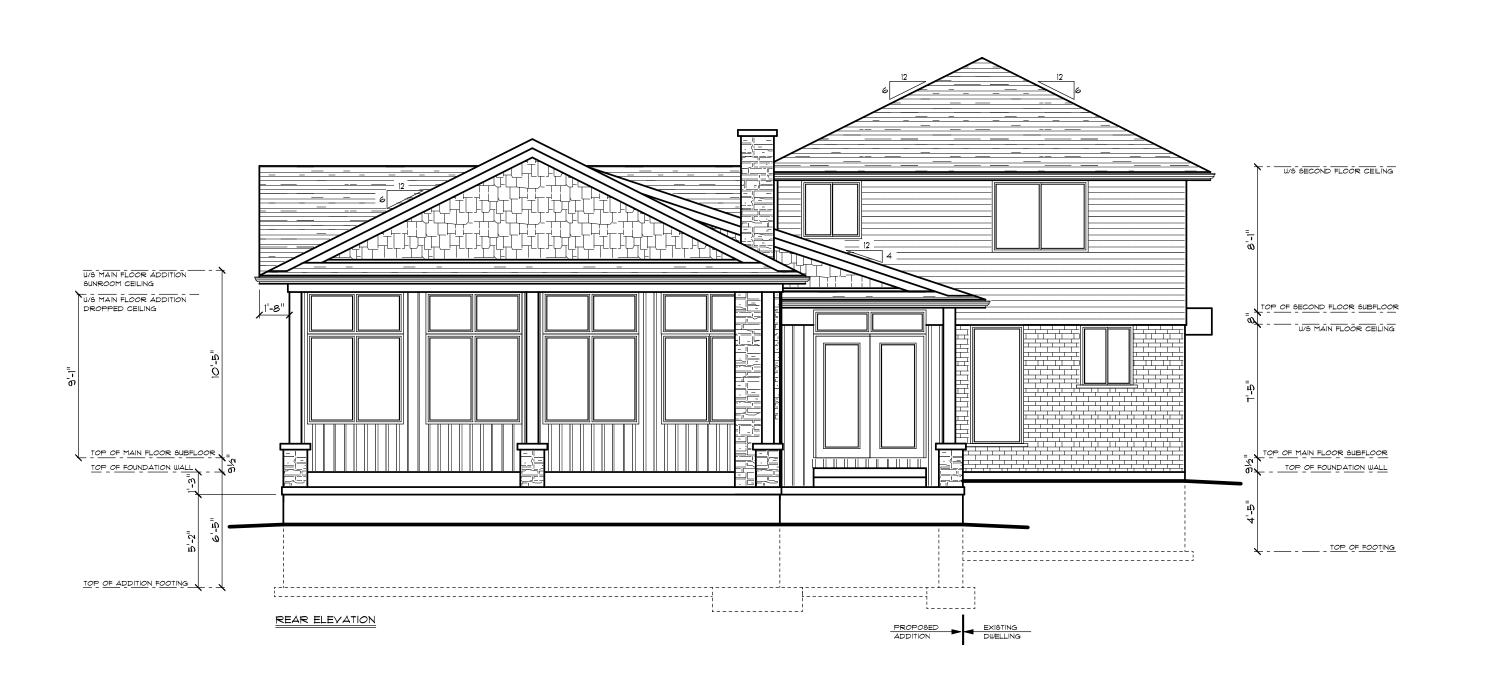

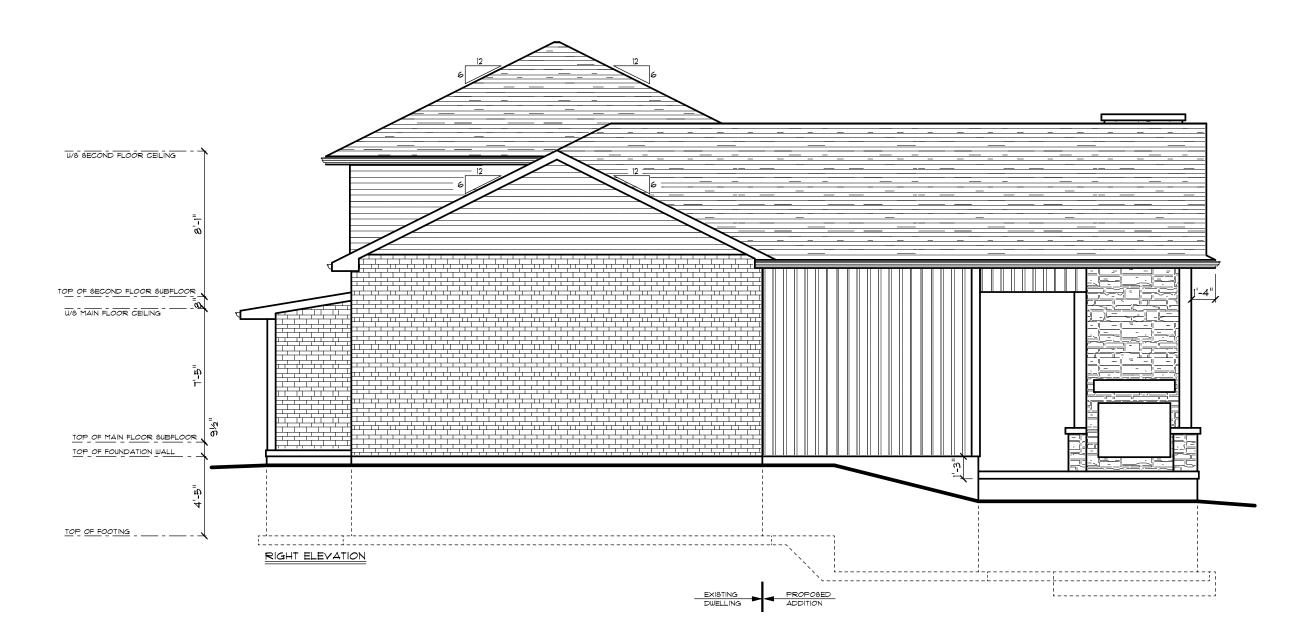

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A CONCRETE PERIMETER WALL FOUNDATION BELOW.

CONCRETE NOTES

ALL ADDITION FOUNDATION WALLS TO BE 8" POURED CONCRETE C/W 6"x20" CONCRETE FOOTINGS.

#### FRAMING NOTES

USE (3) 2"X8" HEADERS C/W 2-2X6 POSTS (1 JACK + 1 KING) UNLESS OTHERWISE NOTED.

TRUSSED ROOF AS PER MANUFACTURERS' SPECIFICATIONS, ROOF OVER FRAME RAFTERS TO BE 2"X6" \*\* 16" O.C. C/W 2"X4" COLLAR TIES AS REQUIRED UNLESS OTHERWISE NOTED. RIDGE, HIP AND VALLEY RAFTERS TO BE 2"X10" WITH SUPPORT AS REQUIRED UNLESS OTHERWISE NOTED.

#### GENERAL NOTES

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### R.P.M. CONSTRUCTION

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## SPRAGGETT RES.


ROCKWOOD


ONTARIO

RAWING TITLE

## REAR & RIGHT ELEVATIONS

ı	DRAWN	SCALE	DRAWING NO:
ı	C.F.	3/16"=1'-0"	
ı	DATE	FILE NO:	Д-4
ı	MAY 18, 2021	600-100-21	

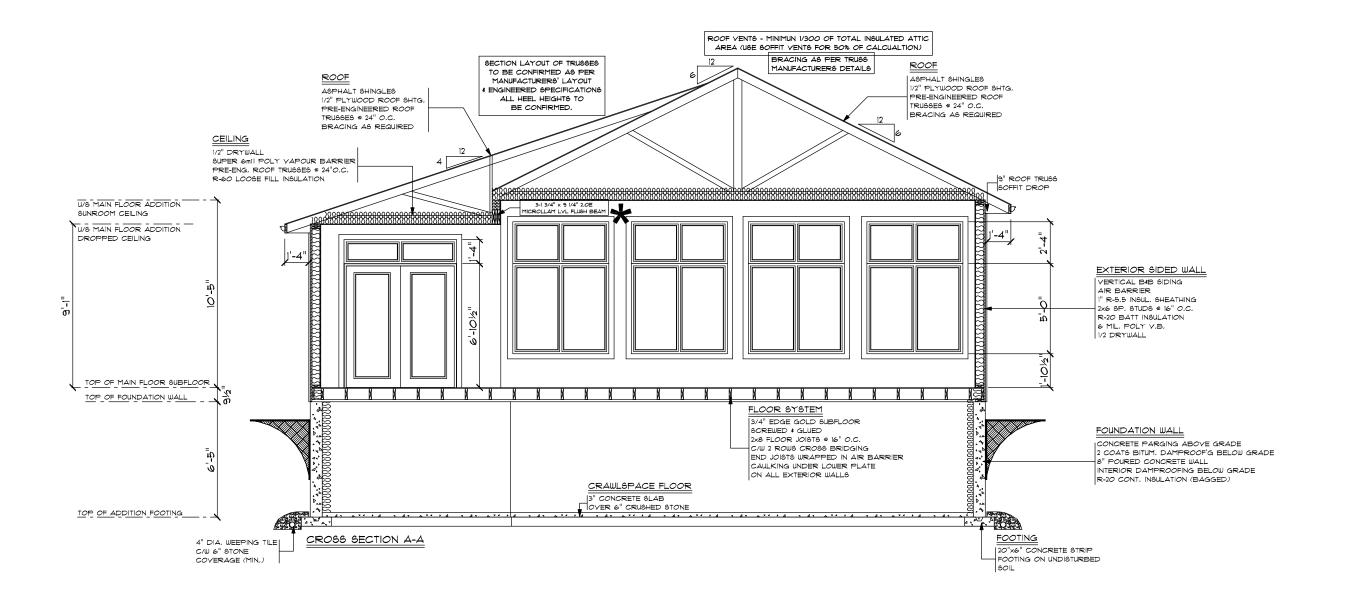

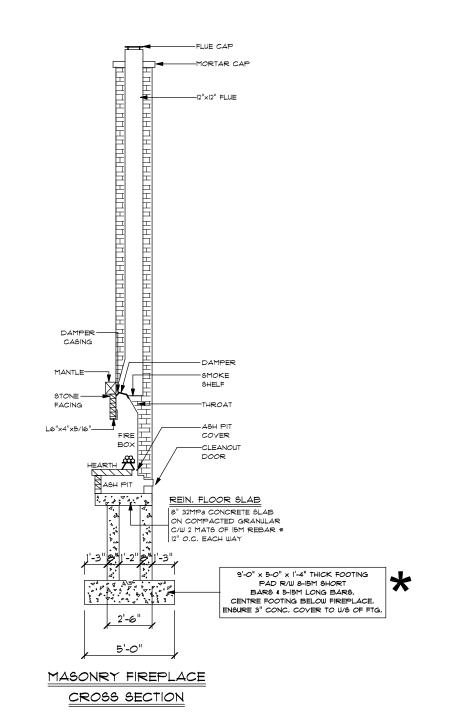

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LTD.
CUSTOM RESIDENTIAL
ELMIRA, ONTARIO
(519) 669-1217

### SPRAGGETT RES.

ROCKWOOD

ONTARIO

DRAWING TITLE

# CROSS SECTION A-A # FIREPLACE SECTION

DRAWN	SCALE	DRAWING NO:
C.F.	3/16"=1'-0"	
DATE	FILE NO:	み-5
MAY 18, 2021	600-100-21	